CIVIL WORKS CITY OF WHITTLESEA 405 EPPING ROAD, WOLLERT VIC 3750 STAGE 1




GENERAL NOTES

- THESE DRAWINGS ARE TO BE READ IN CONJUNCTION WITH EDCM GUIDELINES, CITY OF WHITTLESEA SPECIFICATIONS AND STANDARD DRAWINGS. WORKS SHALL BE CARRIED OUT TO THE SATISFACTION OF THE SUPERINTENDENT OR HIS/HER REPRESENTATIVE.
- THE COLINCIL AND ALL SERVICE AUTHORITIES SHOULD BE NOTIFIED BY THE CONTRACTOR. ITING SEVEN DAYS PRIOR TO COMMENCEMENT OF THE WORKS, ALL EXISTING VICES IN THE VICINITY OF THE WORKS ARE TO BE LOCATED PRIOR TO COMMENCEMENT.
- THE CONTRACTOR SHALL ENSURE THAT NO POLLUTANT OR SEDIMENT LADEN RUNOFF IS DISCHARGED DIRECTLY OR INDIRECTLY INTO ANY DRAINS OR WATER COURSES AND THAT WORKS CONFORM TO THE ENVIRONMENTAL MANAGEMENT PLAN.
- RUNOFF FROM AREAS ON WHICH FARTHWORKS ARE CARRIED OUT MUST BE COLLECTED. AND TREATED TO THE SATISFACTION OF THE RESPONSIBLE AUTHORITY BY THE USE OF OPEN DRAINS, FILTRATION TRAPS AND RETARDING BASINS IN THE PERIOD BETWEEN THE COMMENCEMENT OF CONSTRUCTION WORKS AND THE END OF THE MAINTENANCE PERIOD MAINTENANCE PERIOD BETWEEN THE COMMENCEMENT OF CONSTRUCTION WORKS AND THE END OF THE MAINTENANCE PERIOD MAINTEN IN ACCORDANCE WITH THE ENVIRONMENT MANAGEMENT PLAN FOR THE SUBDIVISIONAL CONSTRUCTION WORKS.
- THE CONTRACTOR SHALL COMPLY WITH ALL OCCUPATIONAL HEALTH AND SAFETY PROCEDURES AND REQUIREMENTS.
- AT LEAST 3 DAYS BEFORE COMMENCING EXCAVATION OF TRENCHES IN EXCESS OF 1.5m DEPTH, A COMPLETED "NOTICE OF INTENTION TO COMMENCE TRENCHING OPERATIONS" FORM SHALL BE SENT TO WORKSAFE VICTORIA. THE NOMINATED SUPERVISOR SHALL BE SUITABLY QUALIFIED IN ACCORDANCE THE VICTORIAN OHS ACT 1985 & COMMONWEALTH OHS CODE OF PRACTICE 2008.
- THE CONTRACTOR SHALL FRECT AND MAINTAIN ALL SHORING, PLANKING AND STRUTTING. DEWATERING DEVICES BARRICADES, SIGNS, LIGHTS, ETC., NECESSARY TO KEEP WORKS IN A SAFE AND STABLE CONDITION AND FOR THE PROTECTION OF THE PUBLIC.
- ALL TREES AND SHRUBS ARE TO BE RETAINED UNLESS APPROVAL IS GIVEN BY COUNCIL'S LANDSCAPE OFFICER OR REMOVAL HAS BEEN GRANTED IN A PLANNING PERMI
- DISPOSAL OF EXCESS SPOIL:- TRUCK ROUTE AND DISPOSAL LOCATION SHALL BE
- 10. ALL AREAS SHOWN ON THE DRAWINGS TO BE CUT OR FILLED ARE TO BE STRIPPED OF ALL AREAS SHOWN ON THE DRAWINGS TO BE OUT OF FILED ARE TO BE STRIPPED OF TOPSOIL TO A DEPTH AS SPECIFIED IN GEOTECHNICAL REPORT PREPARED BY GEOTESTA 2 SEPTEMBER 2019, REPORT NO. GE6550-19. UPON COMPLETION OF THE BULK EARTHWORKS, THE TOPSOIL IS TO BE SPREAD TO A DEPTH OF 100mm OVER THE AREA AND GRADED TO FINISHED LEVELS SHOWN ON THE DRAWINGS AND TO THE SATISFACTION OF THE SUPERINTENDENT. ALL FILLING ON LOTS IN EXCESS OF 300mm IS TO BE CARRIED OUT IN ACCORDANCE WITH A \$ 3798 APPENDIX B. SECTION B2(A) "I EVEL 1" AT COMPLETION. THE ACCORDANCE WITH A \$ 3798 APPENDIX B, SECTION B2(A) 'LEVEL 1'. AT COMPLETION, THE CONTRACTOR SHALL PRESENT A SOIL REPORT FROM A N.A.T A TESTING AUTHORITY, NOMINATING THE EXTENT OF FILL AND IT'S CONFORMANCE WITH THE SPECIFICATION. FILLING TO BE CARRIED OUT USING APPROVED MATERIAL. TOPSOIL AND ALL VEGETABLE MATERIAL TO BE STRIPPED FROM FILL SITE PRIOR TO ANY PLACEMENT OF MATERIAL. ALL FILLING IS TO BE COMPACTED IN 150mm. MAX. DEPTH LAYERS TO 95% OF AS1289.5.1.1
- 11. ALL STORMWATER DRAINS ARE TO BE CLASS '2' RC OR FRC PIPES UNLESS OTHERWISE ALL STONWING HE OF WARMS ARE 10 BE CLUSS 2 FOR FIRE PIECES OF INCESS OF INCE
- TELECOMM. CONDUITS AND CABLE DUCTS WILL BE LAID IN TRENCHES EXCAVATED AND BACKFILLED BY THE CONTRACTOR. THE CONTRACTOR SHALL GIVE THE TELECOMM. AUTHORITY AREA ENGINEER 7 DAYS NOTICE PRIOR TO COMMENCING WORK.
- 13 100mm DIAMETER AGRICULTURAL DRAINS TO BE CONSTRUCTED BEHIND ALL KERR AND CHANNEL IN ACCORDANCE WITH EDCM 202 AND LAID AT A MINIMUM OF 300mm BELOV SUBGRADE OF ROAD PAVEMENT WITH CLEARANCE TO ALL SERVICE CONDUITS.
- WHERE DRAINAGE PIPES ARE LAID ON A CURVE THE BUILDING LINE IS TO BE PEGGED AT
- 15. THE REINSTATEMENT AND COMPACTION OF SERVICE AUTHORITY TRENCHES SHALL BE THE CONTRACTOR'S RESPONSIBILITY
- ALL P.S.M.s SHALL BE HIGH STABILITY TYPE AND LEVELLED BY A LICENSED SURVEYOR AND THE P.S.M. DATA SHALL BE FORWARDED TO COUNCIL.
- 17. ALL CONDUIT ENDS SHALL BE PLUGGED WITH DRAW WIRE AS APPROPRIATE.
- 18. ALL DRAINAGE TRENCHES WITHIN 5.0m OF ANY TREE TO BE RETAINED SHALL BE THRUST
- BORED OR HAND DUG 19. FILL MATERIAL UNDER ROAD PAVEMENT SHALL BE APPROVED MATERIAL AND
- FILL MATERIAL UNDER NOVA PAYEMIENT STALLE BE AFFROVED WATERIAL AND CONSTRUCTED IN LAYERS OF 150mm THICKNESS WITH COMPACTION ACHIEVING 98 (STANDARD COMPACTION) AT A MOISTURE RATIO OF 90% TO 110% OF AS1289.5.1.1 20. ALL LINEMARKING AND SIGNAGE SHALL BE IN ACCORDANCE WITH AS1742.1 AND AS1742.2. LONG LIFE PAINT SHALL BE USED FOR LINEMARKING
- 21. ALL ELECTRICITY CONDUITS ARE TO BE A MINIMUM 63mm DIAMETER. ALL TELSTRA CONDUITS ARE TO BE A MINIMUM 100mm DIAMETER. REFER TO ELECTRICAL AND TELECOMMUNICATION PLANS FOR DETAILS.
- 22. THE CONTRACTOR SHALL NOTE THE EXISTENCE OF TELECOMMUNICATIONS, GAS POWER WATER AND ANY OTHER SERVICES IN THE AREA PRIOR TO TENDERING / CONSTRUCTION
- 23. ANY DISTURBANCE TO EXISTING INFRASTRUCTURE DUE TO CONSTRUCTION WORKS SHALL BE RECTIFIED AT THE CONTRACTOR'S EXPENSE.
- ALL NATURE STRIPS AND BATTERS SHALL BE COVERED WITH 100mm MIN, DEPTH TOPSOIL AND SEEDED WITH AN APPROVED SEED AND FERTILIZER MIXTURE AS PER GAA GUIDELINES
- a. CONDUITS UNDER FOOTPATHS TO BE 450mm DEEP EXTENDING 250mm EITHER SIDE OF THE PATH THE FOOTPATH ABOVE THE CONDUITS SHALL BE MARKED WITH TWO CONTRACTION JOINTS OVER THE CONDUITS 400mm APART
- CONDUITS SHALL BE REFERENCED ON BOTH FOOTPATH AND KERB & CHANNEL
- CONDUITS SHALL BE REFERENCED ON BOTH FOUND HAITH AND AREA & CHANNEL.
 CONDUITS INSTALLED DIVER ROAD PAYEMENTS SHALL EXTEND 1 METRE INSIDE THE ALLOTMENTS WHERE FOOTPATH IS PROPOSED.
 GAS TO BE 50mm DIA CLASS 12 PVC & WATER CONDUIT TO BE DN100 SINGLE CONDUIT CONTAINING BOTH DW & NDW SERVICES LAID IN ACCORDANCE WITH WSA 03-2011-3.1
- AND DRAWING MRWA-W-202 & MRWA-W-110.
- 27 LIPON COMPLETION OF THE WORKS THE WHOLE SITE SHALL BE CLEANED AND ALL RUBBISH. REMOVED, LOTS ARE TO BE GRADED EVENLY AND THE SITE LEFT IN A CLEAN AND TIDY CONDITION TO THE SATISFACTION OF THE SUPERINTENDENT.

- 28. NO TOPSOIL SHALL BE REMOVED FROM THE SITE
- INSPECTIONS SHALL BE ARRANGED A MINIMUM OF 24 HOURS BEFORE WITH COUNCILS ASSETS ENGINEER.
- 30 STREET SIGNS SHALL BE MANUFACTURED IN ACCORDANCE WITH CITY OF WHITTI ESFA STANDARDS INCLUDING LOGO AND TO COMPRISE TWO FINGER BOARDS
- 24 HOURS NOTICE IS REQUIRED FOR INSPECTION AT THE FOLLOWING HOLD POINTS:
- PRIOR TO COMMENCEMENT OF THE WORKS.
- INSPECTION OF THE SUBGRADE. INSPECTION DURING DRAINAGE WORKS.
- INSPECTION PRIOR TO POURING OF PITS.

- INSPECTION OF SUB SOIL DANIANGE.
 INSPECTION OF SUB SOIL DANIANGE.
 INSPECTION OF KERB AND CHANNEL BEDDING.
 INSPECTION PRIOR TO ANY CONCRETE WORKS.
 INSPECTION AND TESTING OF EACH PAVEMENT LAYER (BY DEVELOPER OR CONTRACTOR) PRIOR TO PLACING ANY SUBSEQUENT PAVEMENT LAYER. COMPACTION TEST RESULTS SHALL BE ISSUED TO COUNCIL
- INSPECTION PRIOR TO SEALING AND ASPHALT WORKS.
- 32. COUNCIL WILL NOT ACCEPT ANY RESPONSIBILITY FOR WORKS WHERE AN INSPECTION IS NOT UNDERTAKEN WITH A COUNCIL APPOINTED REPRESENTATIVE
- 33. ALL DIMENSIONS ARE IN METRES AND RADII TO LIP OF KERB UNLESS OTHERWISE SHOWN.
- 34. LEVELS ARE TO A.H.D. AND TAKEN FROM LEVEL PLANS BY TAYLORS DEVELOPMENT STRATEGISTS. SETOUT CO-ORDINATES ARE BASED ON MGA ZONE 55.
- 35. PITS SHALL BE LOCATED USING OFFSETS AND CO-ORDINATES SHOWN ON DRAWINGS.
- 36. ALL DRAINS BENEATH ROAD PAVEMENT, PATHS, DRIVEWAYS AND PARALLEL TO KERB SHALL BE BACKFILLED WITH 20mm CLASS 2 F.C.R. ALL BACKFILLING TO BE COMPACTED TO 98% OF AS1299.5.1 (STANDARD COMPACTION), DRAINS BEHIND THE BACK OF KERB SHALL BE BACKFILLED USING SELECT FILL COMPACTION OF THE DRAINAGE LINE SHALL BE 95% STANDARD COMPACTION TO AS1289.5.1.1 AND ALL TEST RESULTS SHALL BE SUBMITTED TO
- 37. HOUSE DRAINS SHALL GENERALLY BE PLACED 5.5m FROM THE LOW CORNER OF THE LOT. AS PER EDOM 701 AND PROPERTY INLETS 1.0m FROM AND 0.6m BELOW THE LOW CORNER OF THE LOT, UNLESS OTHERWISE SHOWN.
- 38. ALL PROPERTY INLETS ARE TO HAVE A MINIMUM DEPTH OF 500mm BELOW FINISHED LEVEL.
- 39. HOUSE NUMBERS TO BE STENCILED ON THE FACE OF KERB IN 100mm HIGH LETTERS
- 40. EXISTING OPEN CHANNELS TO BE EXCAVATED TO A FIRM BASE AND BACKFILLED IN EXISTING OPEN CHANNELS TO BE EXCAVATED TO A FIRM BASE AND BACKFILLED IN A ACCORDANCE WITH NOTE 10. CONSULTING ENGINEER TO BE NOTIFIED WHEN THE OPEN CHANNELS HAVE BEEN EXCAVATED TO A FIRM BASE. NO FILLING IS TO BE PLACED PRIOR TO BASE BEING INSPECTED AND LEVELS TAKEN. BACKFILLING IS TO BE CARRIED OUT TO THE SATISFACTION OF THE SUPERINTENDENT
- 41. ALL PAVEMENT MATERIALS ARE TO BE APPROVED BY CITY OF WHITTLESEA.
- 42. ALL PAVEMENTS ARE TO BE TESTED FOR ADEQUATE COMPACTION AND APPROVED PRIOR
- 43. PRIOR TO THE ISSUE OF A STATEMENT OF COMPLIANCE, ALL NEWLY CONSTRUCTED ROADS, FOOTPATHS AND DRAINAGE ASSETS ARE TO BE RECORDED UNDER THE "D-SPEC" & "R-SPEC" SYSTEM AS SETOUT IN THE GAA GUIDELINES AND THE RESULTS PROVIDED TO
- 44. NO FILL OR EXCAVATED MATERIAL FOR OR FROM THIS DEVELOPMENT IS TO BE CARTED/HAULED INTO OR FROM THE SITE, WITHOUT FIRST OBTAINING THE FURTHER WRITTEN CONSENT FROM COUNCIL'S ENGINEERING DEPARTMENT AT LEAST SEVEN (7)
 DAYS PRIOR TO THE CARTAGE/HAULAGE WORKS COMMENCING, TO THE SATISFACTION OF THE RESPONSIBLE AUTHORITY.
- 45. ALL FARTHWORKS MUST BE UNDERTAKEN IN A MANNER THAT MINIMISES SOIL FROSION AND ANY EXPOSED AREAS OF SOIL MUST BE STABILISED TO PREVENT SOIL EROSION TO THE SATISFACTION OF THE RESPONSIBLE AUTHORITY
- 46. EROSION MUST BE CONTROLLED DURING CONSTRUCTION IN ACCORDANCE WITH THE ENVIRONMENT PROTECTION AUTHORITY GUIDELINE TG208/90. CONTRACTOR TO PROVIDE SITE EMP.
- 47. ALL VEGETATION THAT IS REMOVED AND DISPOSED OF MUST:
 - NOT CAUSE DAMAGE TO VEGETATION STANDS TO BE RETAINED . HAVE REGARD TO THE LOCAL LAW WHEN BURNING VEGETATION
- 48. NATIVE VEGETATION REMOVAL TO BE LIMITED TO THE SPECIFIC PLANTS IDENTIFIED AS PART OF THE PLANNING PERMIT. NO ADDITIONAL NATIVE PLANTS, OUTSIDE OF THOSE SPECIFIED IN THE PLANNING PERMIT, ARE TO BE REMOVED.
- 49. NO POLLUTED AND/OR SEDIMENT LADEN RUNOFF IS TO BE DISCHARGED, DIRECTLY OR INDIRECTLY, INTO MELBOURNE WATER'S DRAINS OR WATERCOURSES.
- 50. BEFORE THE VEGETATION REMOVAL STARTS, THE BOUNDARIES OF ALL VEGETATION TO BE REMOVED AND RETAINED MUST BE CLEARLY MARKED WITH TEMPORARY FENCING, TO THE SATISFACTION OF THE RESPONSIBLE AUTHORITY. THE REMOVAL MUST BE IN ACCORDANCE WITH THE ENDORSED PLAN.
- 51. PRIOR TO FELLING, TREES IDENTIFIED FOR REMOVAL MUST BE EXAMINED FOR THE PRESENCE OF FAUNA, INCLUDING THOSE USING EXTERNAL NESTS (e.g COMMON RINGTAIL POSSUMS, BIRDS NESTS) AND TREE HOLLOWS. IF NATIVE FAUNA SPECIES ARE LOCATED, THEY ARE TO BE SALVAGED AND RELOCATED IN ACCORDANCE WITH ALL RELATIVE LEGISLATION AND APPROVALS, FURTHER TO CONSULTATION WITH THE DEPARTMENT OF SUSTAINABILITY AND ENVIRONMENT.
- 52. ALL VEHICLES, EARTHMOVING EQUIPMENT AND OTHER MACHINERY MUST BE CLEARED OF SOIL AND PLANT MATERIAL BEFORE ENTERING AND LEAVING THE SITE, TO PREVENT THE SPREAD OF WEEDS AND PATHOGENS
- 53. DRIVEWAYS TO BE EXCAVATED INTO ALLOTMENTS AT A MAXIMUM GRADE OF 1 IN 5 WHERE
- 54. DRIVEWAY LAYBACK AND WINGS ARE TO BE CONSTRUCTED AS A SINGLE SEGMENT OF
- 55. ALL NBN PITS ARE TO BE CLEAR OF PATHS AND DRIVEWAYS.
- 56. CONTRACTOR TO PROVIDE CCTV TESTING ON ALL CONSTRUCTED DRAINAGE LINES AND TO BE APPROVED BY COUNCIL PRIOR TO THE ISSUE OF STATEMENT OF COMPLIANC
- 57. ALL RESIDENTIAL AND HEAVY DUTY DRIVEWAYS TO BE CONSTRUCTION ACCORDING TO MPA

DRAWING INDEX									
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21408-01-E-101	EXISTING FEATURES PLAN	2							
21408-01-E-102	TYPICAL SECTIONS AND DETAILS	3							
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21408-01-E-104	ROAD CENTRELINE SETOUT PLAN	5							
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LOCALITY PLAN SCALE N.T.S. MELWAYS REF MAP 389 C10

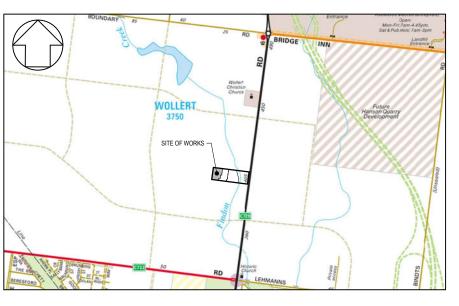SERVICE OFFSET TABLE													
STREET	(GAS		D WATER DW)	POTABLE (D	WATER W)	TELE	COMS	-	TRICAL BLES	SE	WER	
JINEET	SIDE	OFFSET	SIDE	OFFSET	SIDE	OFFSET	SIDE	OFFSET	SIDE	OFFSET	SIDE	OFFSET	
COTTONWOOD DRIVE	SOUTH	2.10M	SOUTH	2.50M	SOUTH	3.00M	NORTH	0.35M	NORTH	1.10M	SOUTH	1.00M	
ELKHORN STREET	WEST	2.10M	WEST	2.50M	WEST	3.00M	EAST	1.85M	EAST	2.60M	EAST	1.00M	
BUTTERNUT STREET	JT STREET SOUTH 2.10M			2.50M	SOUTH	3.00M	NORTH	1.85M	NORTH	2.60M	NORTH	1.00M 1.00M	



	SERVICE OFFSET TABLE													
STREET	G	SAS	RECYCLE (ND		POTABLE (D'		TELE	COMS		TRICAL BLES	SEWER			
SINCE	SIDE	OFFSET	SIDE	OFFSET	SIDE	OFFSET	SIDE	OFFSET	SIDE	OFFSET	SIDE	OFFSET		
COTTONWOOD DRIVE	SOUTH	2.10M	SOUTH	2.50M	SOUTH	3.00M	NORTH	0.35M	NORTH	1.10M	SOUTH	1.00M		
ELKHORN STREET	WEST	2.10M	WEST	2.50M	WEST	3.00M	EAST	1.85M	EAST	2.60M	EAST	1.00M		
BUTTERNUT STREET	SOUTH 2.10M		SOUTH	2.50M	SOUTH	3.00M	NORTH 1.85M		NORTH 1.85M		NORTH	2.60M	NORTH SOUTH	1.00M 1.00M

CONTRACTOR

WARNING

BEWARE OF UNDERGROUND SERVICES


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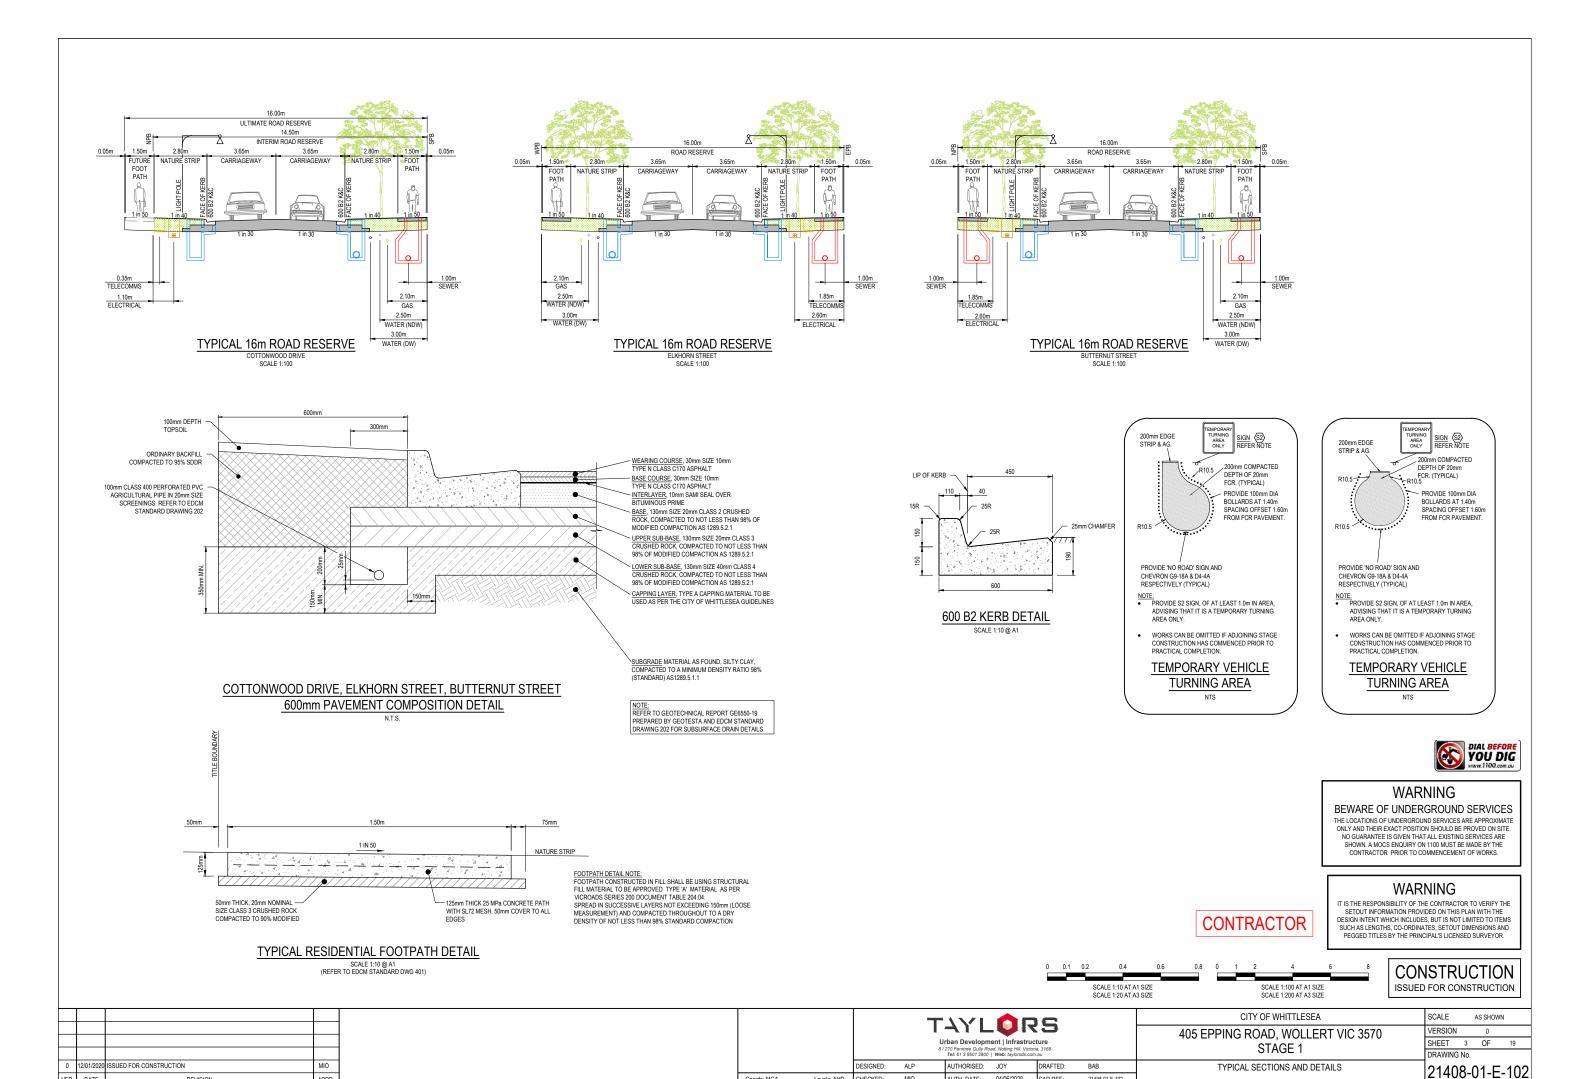
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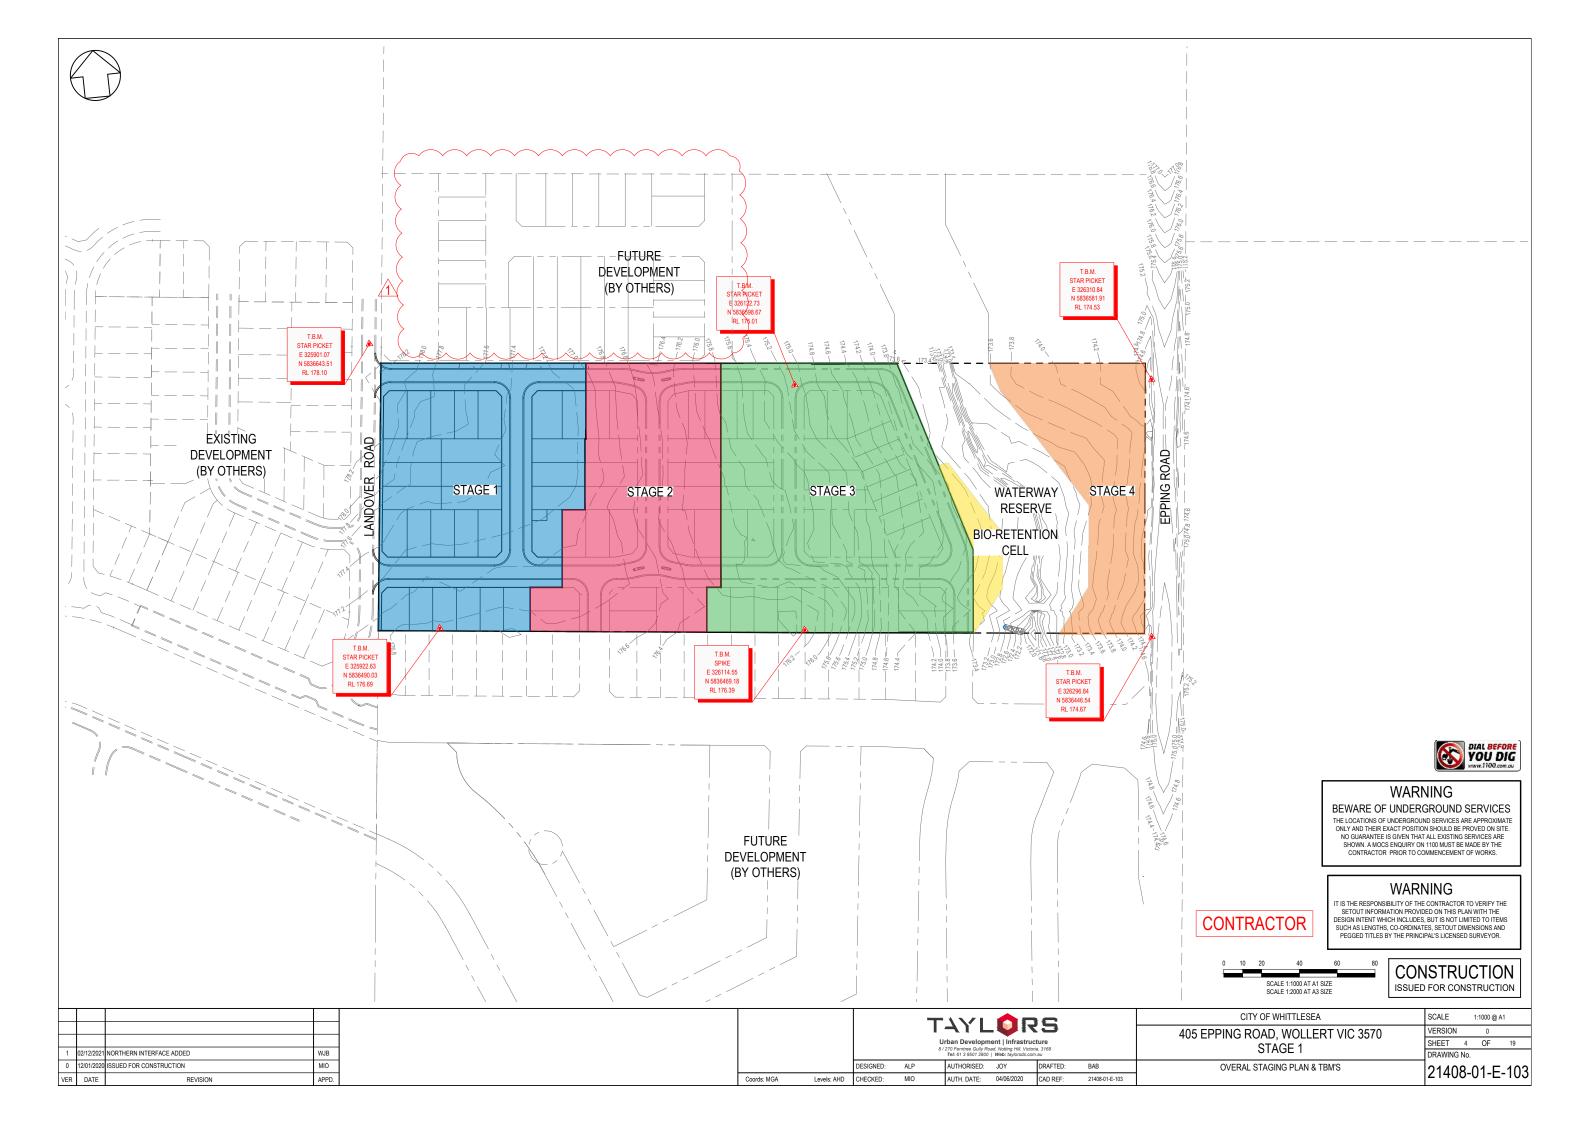
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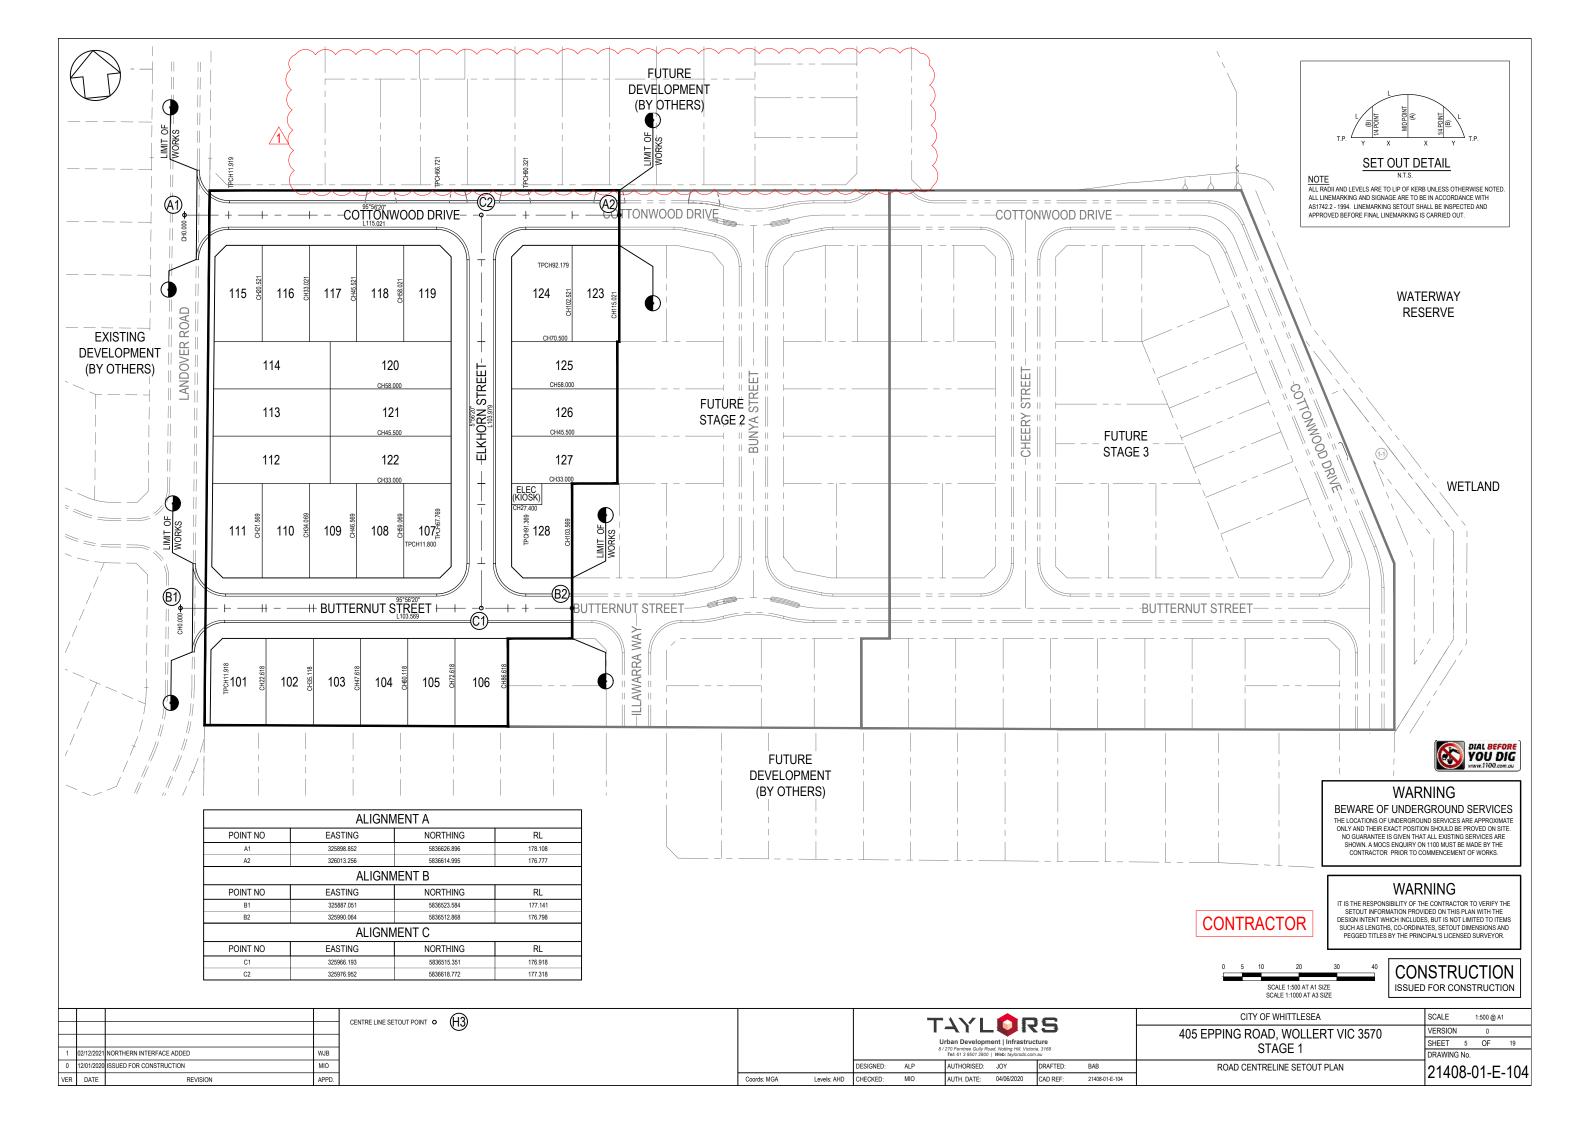
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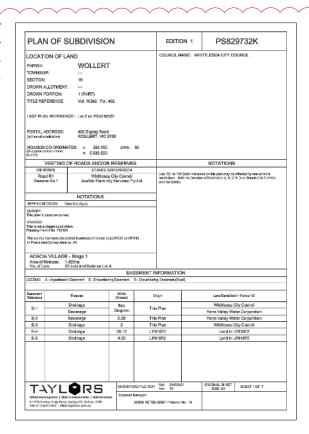
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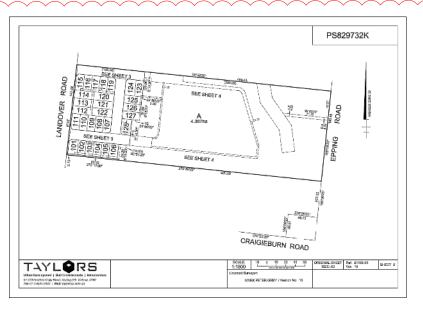
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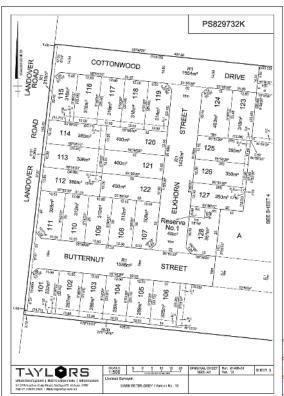
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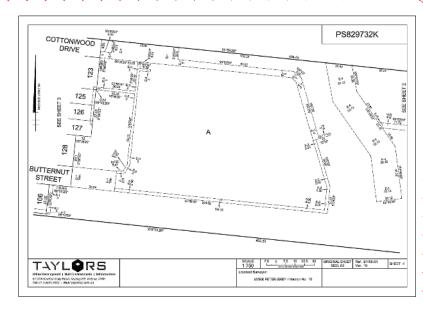













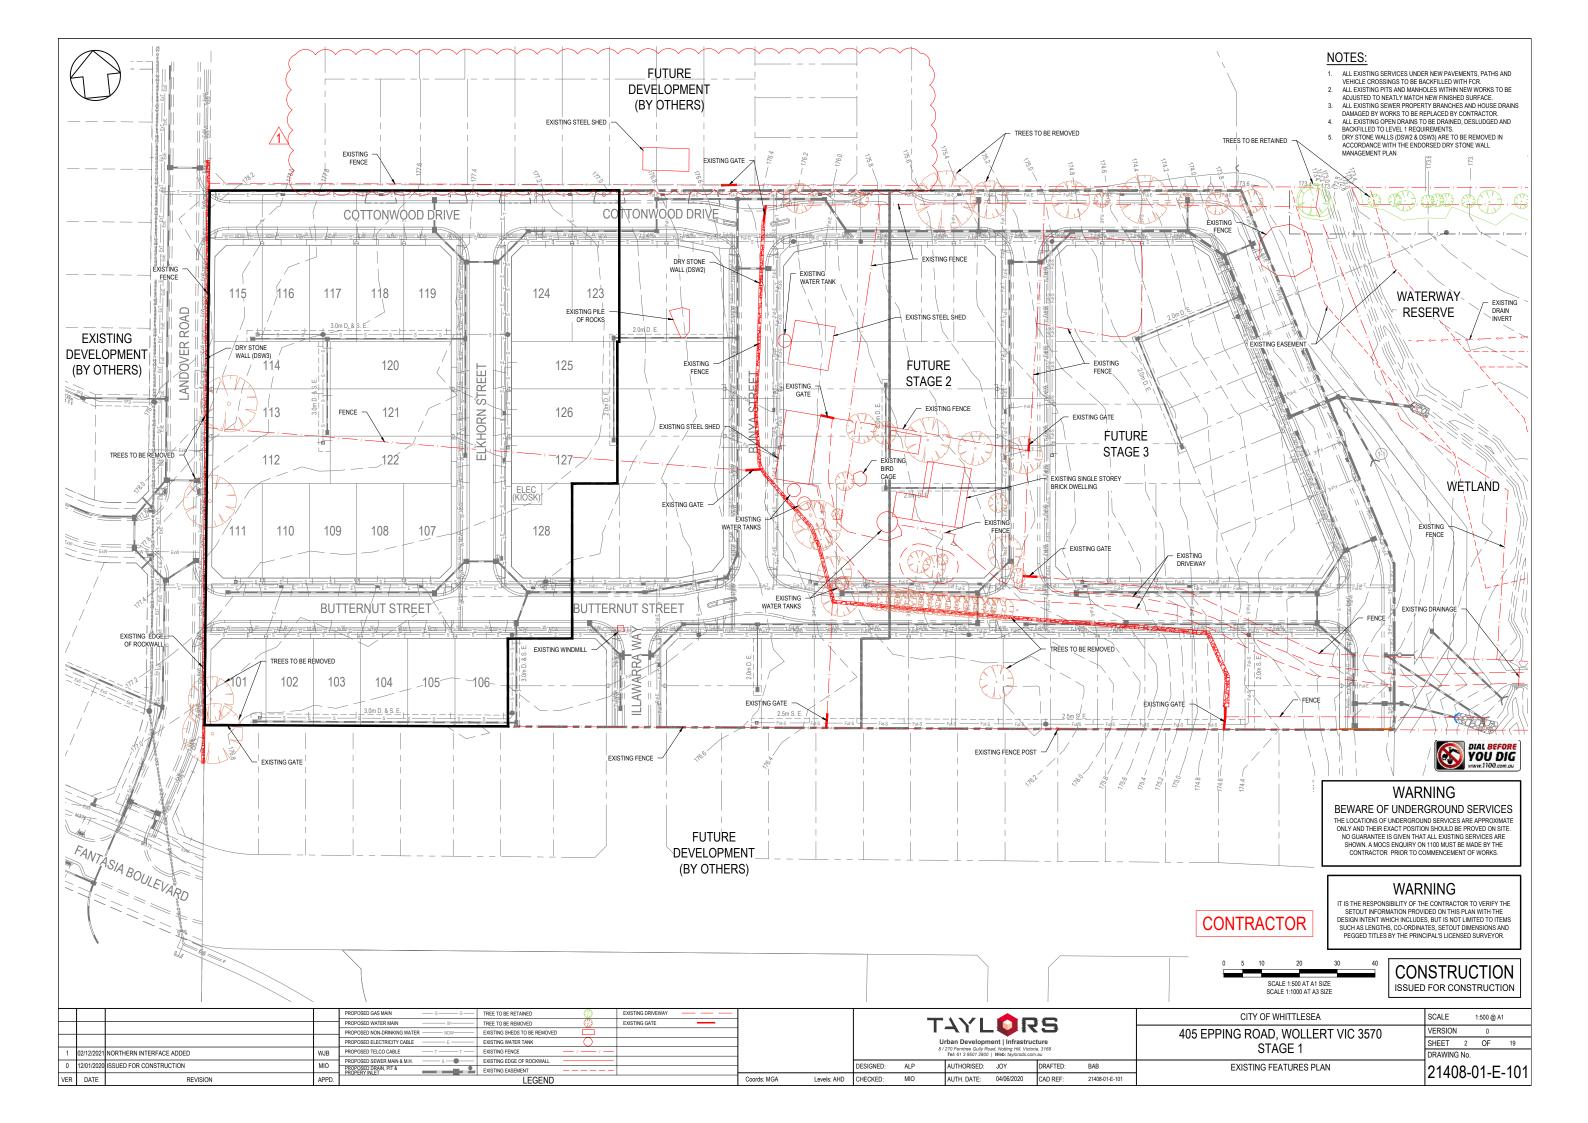

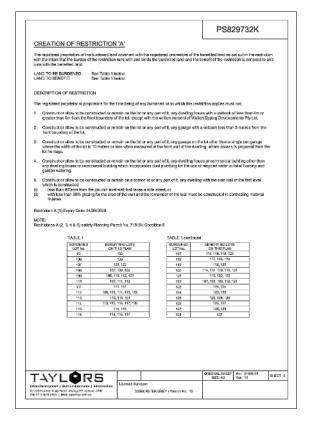

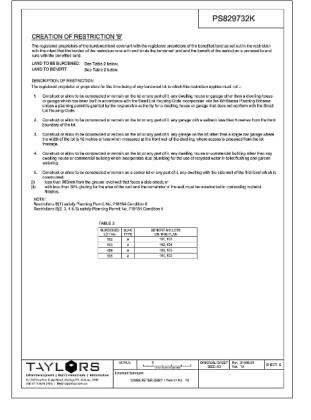

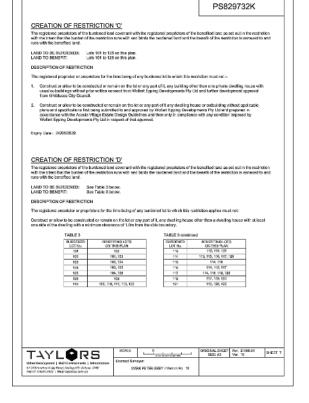



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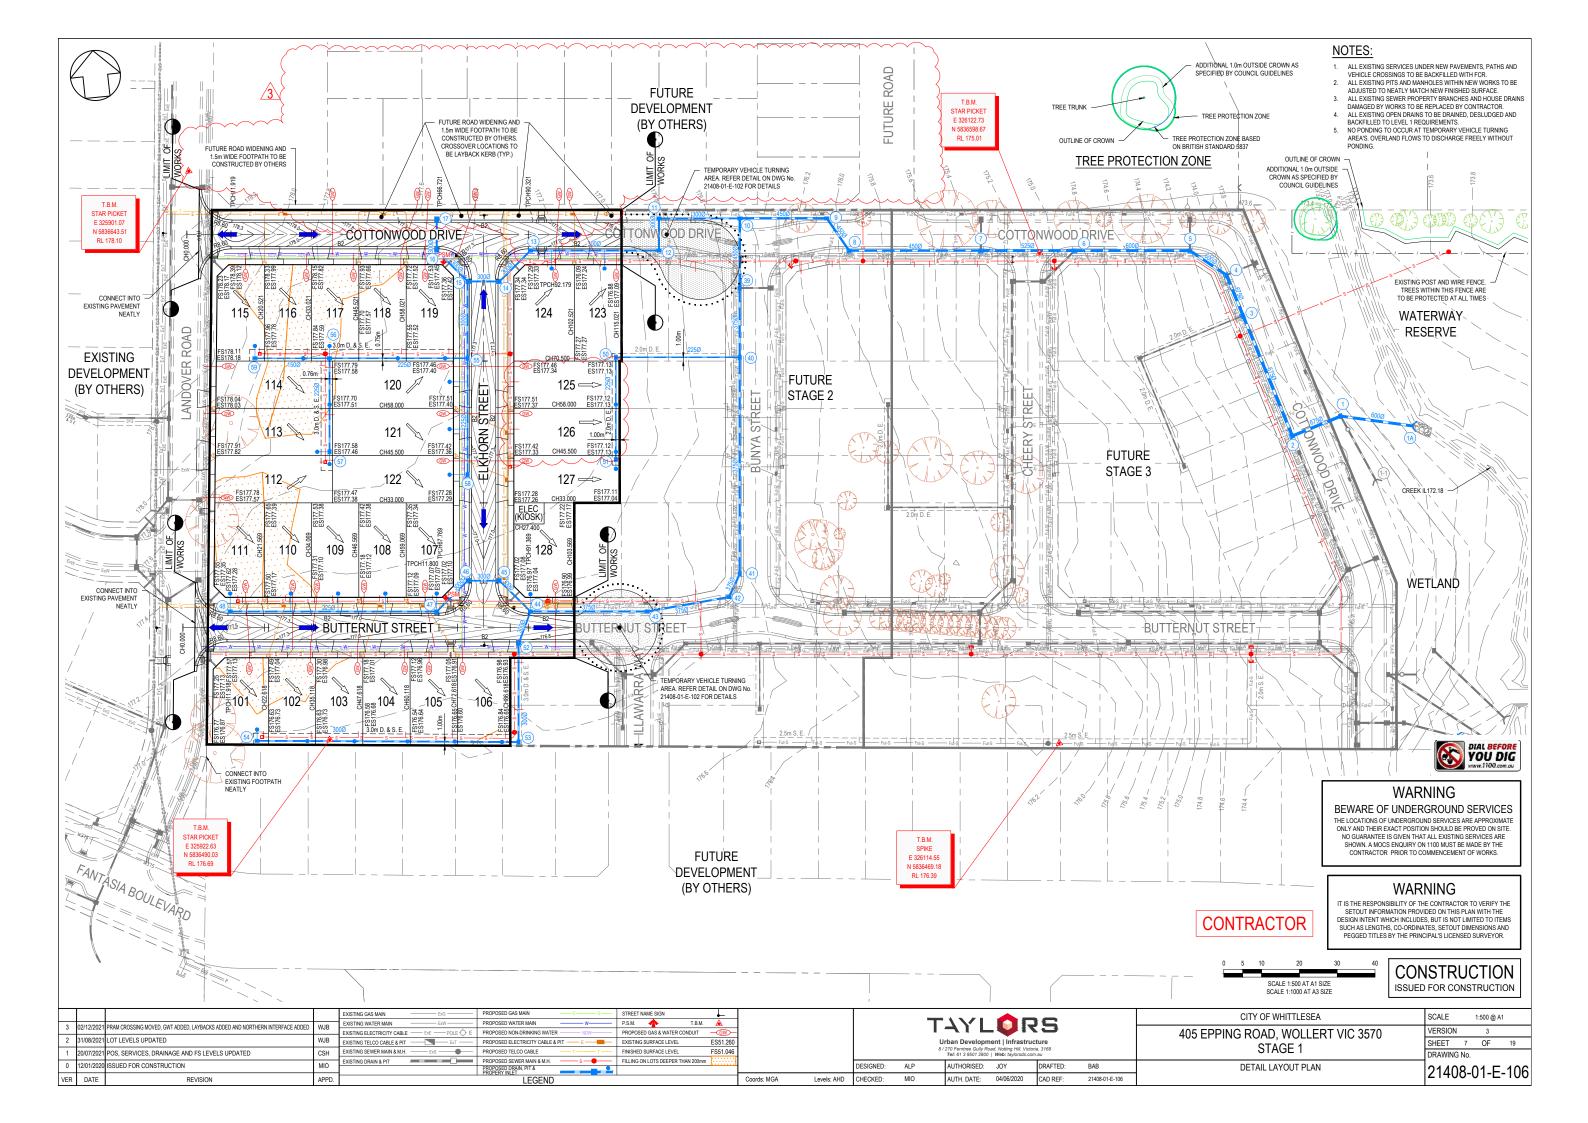
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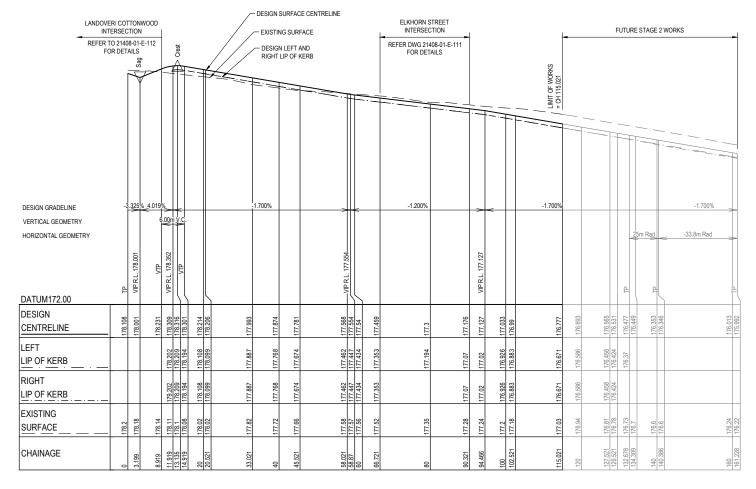
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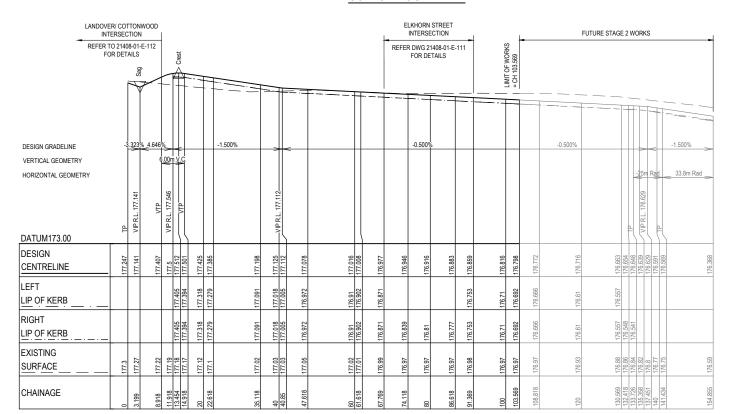
CONSTRUCTION ISSUED FOR CONSTRUCTION

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COTTONWOOD DRIVE



BUTTERNUT STREET


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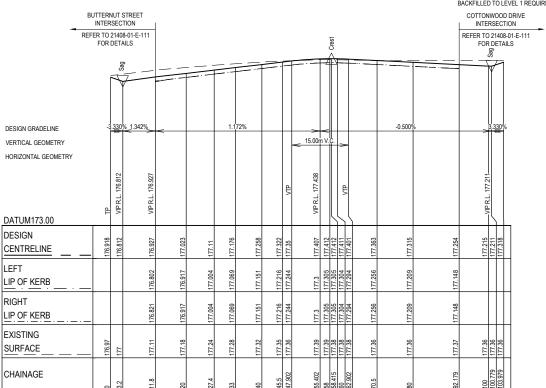
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NOTES: ALL EXISTING SERVICES UNDER NEW PAVEMENTS, PATHS AND 1. ALL EXISTING SERVICES UNIDER NEW PAYMENTS, PATHS AND VEHICLE CROSSINGS TO BE BACKFILLED WITH FOR. 2. ALL EXISTING PITS AND MANHOLES WITHIN NEW WORKS TO BE ADJUSTED TO NEATLY MATCH NEW FINISHED SURFACE. 3. ALL EXISTING SEWER PROPERTY BRANCHES AND HOUSE DRAINS DAMAGED BY WORKS TO BE REPLACED BY CONTRACTOR. 4. ALL EXISTING OPEN DRAINS TO BE DRAINED, DESLUDGED AND BACKFILLED TO LEVEL 1 REQUIREMENTS.



ELKHORN STREET




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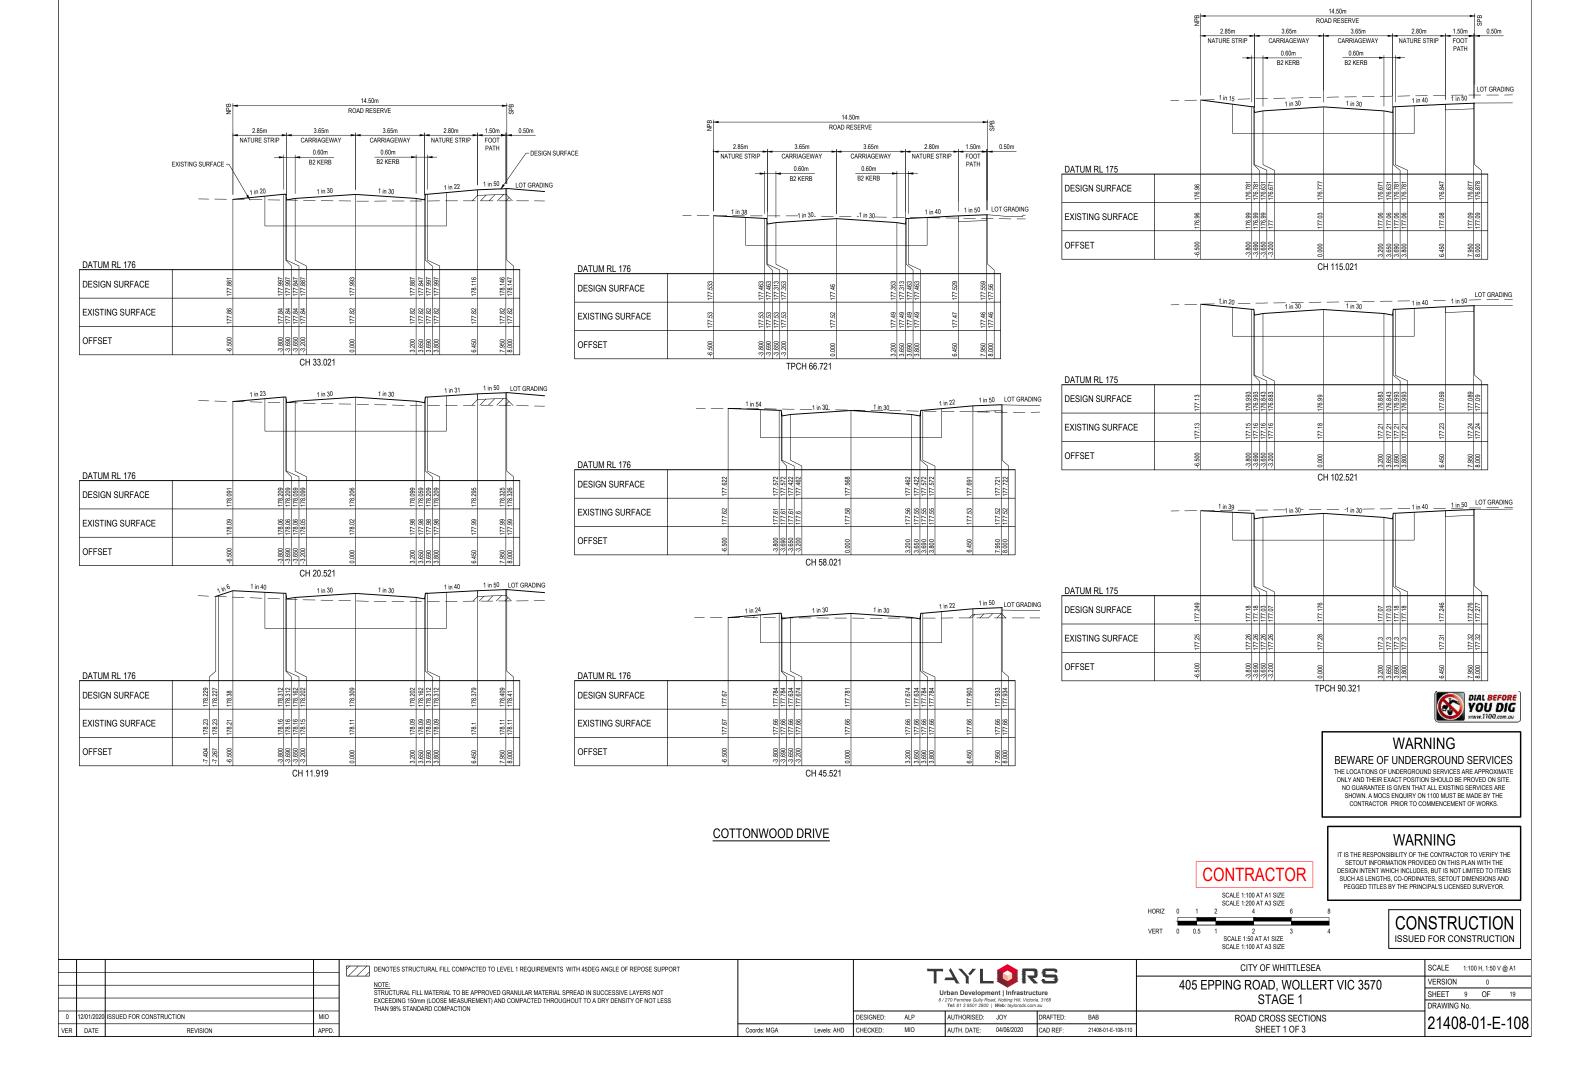
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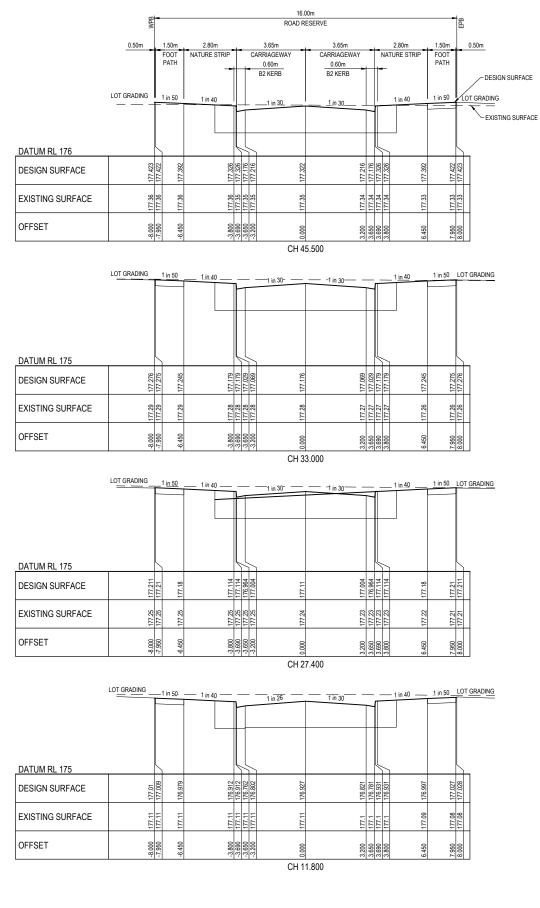
CITY OF WHITTLESEA	SCALE
405 EPPING ROAD, WOLLERT VIC 3570	VERSI
STAGE 1	SHEET
SIAGET	DD 414/

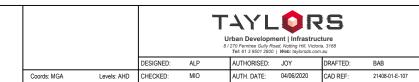
1:500 H, 1:50 V @A1 SION T 8 OF


21408-01-E-107


DRAWING No. ROAD LONGITUDINAL SECTIONS



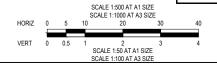

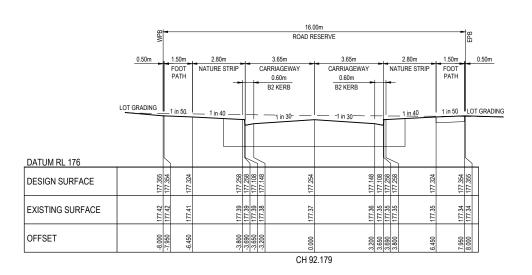

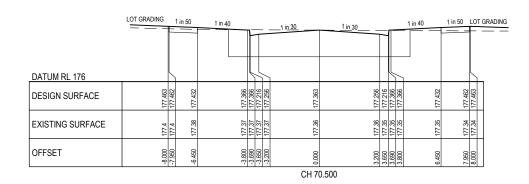

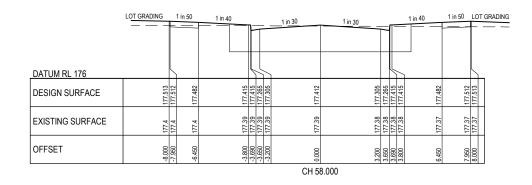




WARNING

BEWARE OF UNDERGROUND SERVICES

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CONTRACTOR

CONSTRUCTION ISSUED FOR CONSTRUCTION

VERSION

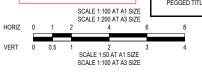DRAWING No.


SCALE 1:100 H, 1:50 V @ A1


SHEET 10 OF 19


21408-01-E-109


ELKHORN STREET

			DENOTES STRUCTURAL FILL COMPACTED TO LEVEL 1 REQUIREMENTS WITH 45DEG ANGLE OF REPOSE SUPPORT					. / // [^	10		CITY OF WHITTLESEA
			STRUCTURAL FILL MATERIAL TO BE APPROVED GRANULAR MATERIAL SPREAD IN SUCCESSIVE LAYERS NOT				- 1	→1 L	- •	3		405 EPPING ROAD, WOLLERT VIC 3570
			EXCEEDING 150mm (LOOSE MEASUREMENT) AND COMPACTED THROUGHOUT TO A DRY DENSITY OF NOT LESS THAN 98% STANDARD COMPACTION					Urban Developm 3 / 270 Ferntree Gully Ro	oad, Notting Hill, Victo	ria, 3168		STAGE 1
								Tel: 61 3 9501 2800	Web: taylorsds.com	n.au		002
0 12/01/2020	20 ISSUED FOR CONSTRUCTION	MIO				DESIGNED:	ALP	AUTHORISED:	JOY	DRAFTED:	BAB	ROAD CROSS SECTIONS
VED DATE	DEVICION	ADDD		Coords: MGA	Lovole: AHD	CHECKED:	MIO	ALITH DATE:	04/06/2020	CAD DEE:	21/08-01-E-108-110	SHEET 2 OF 3

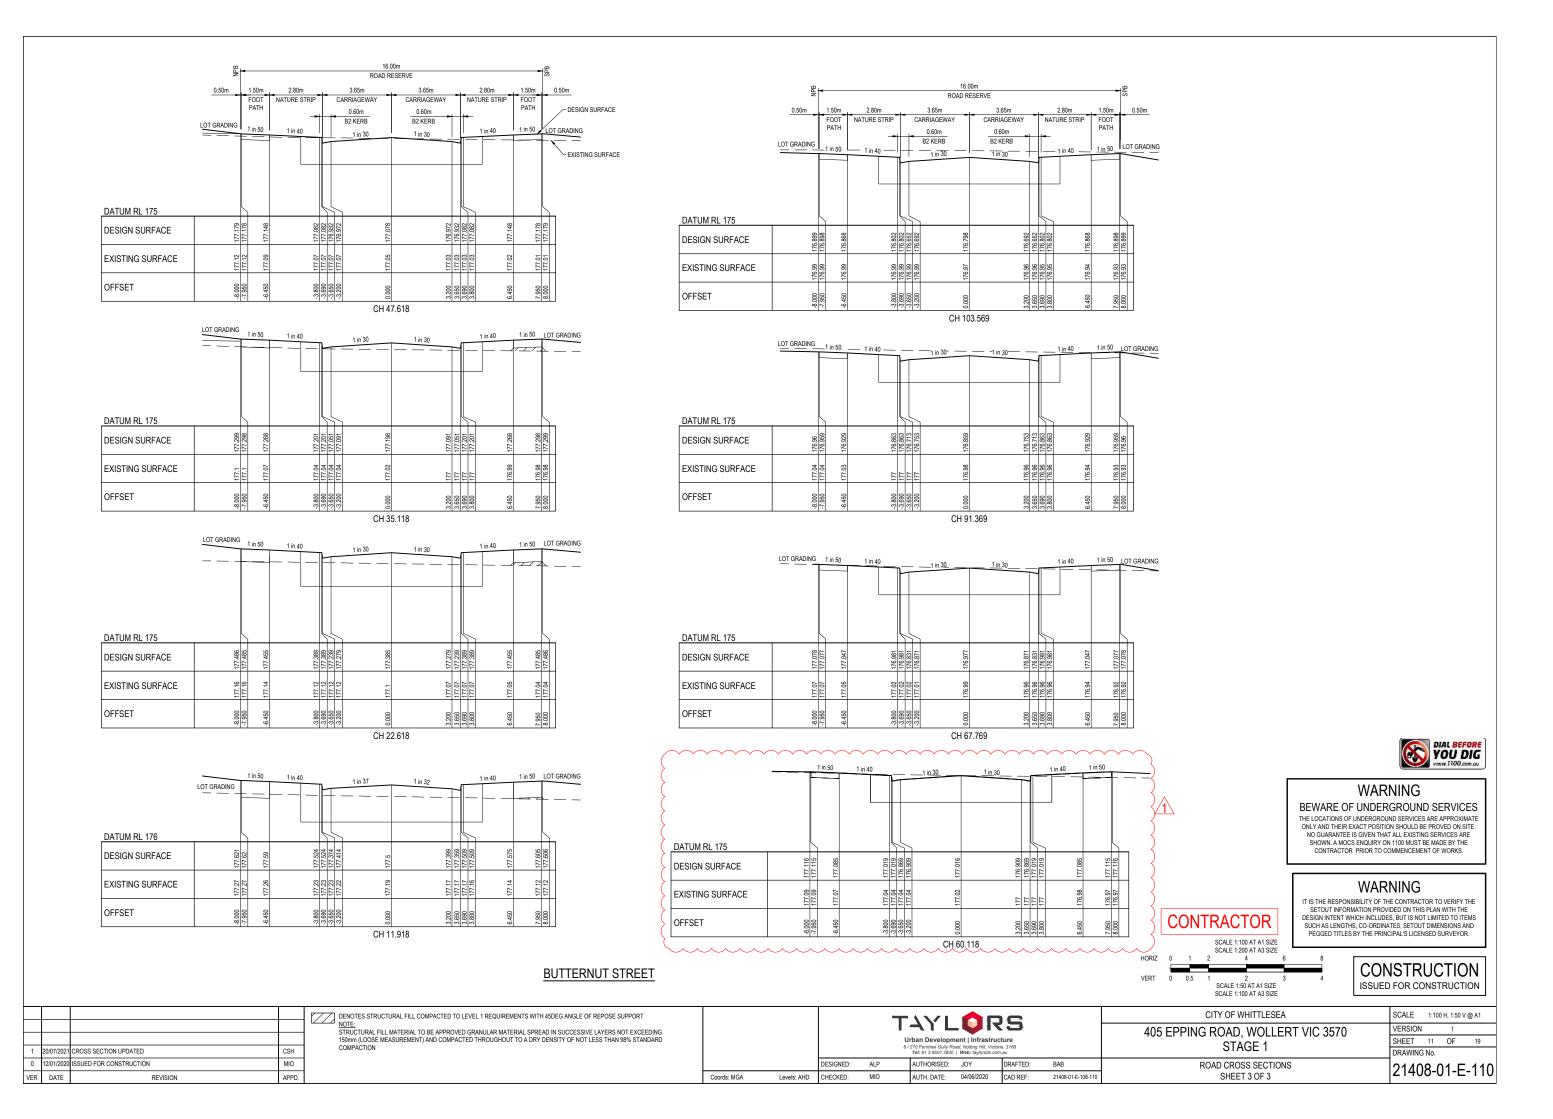

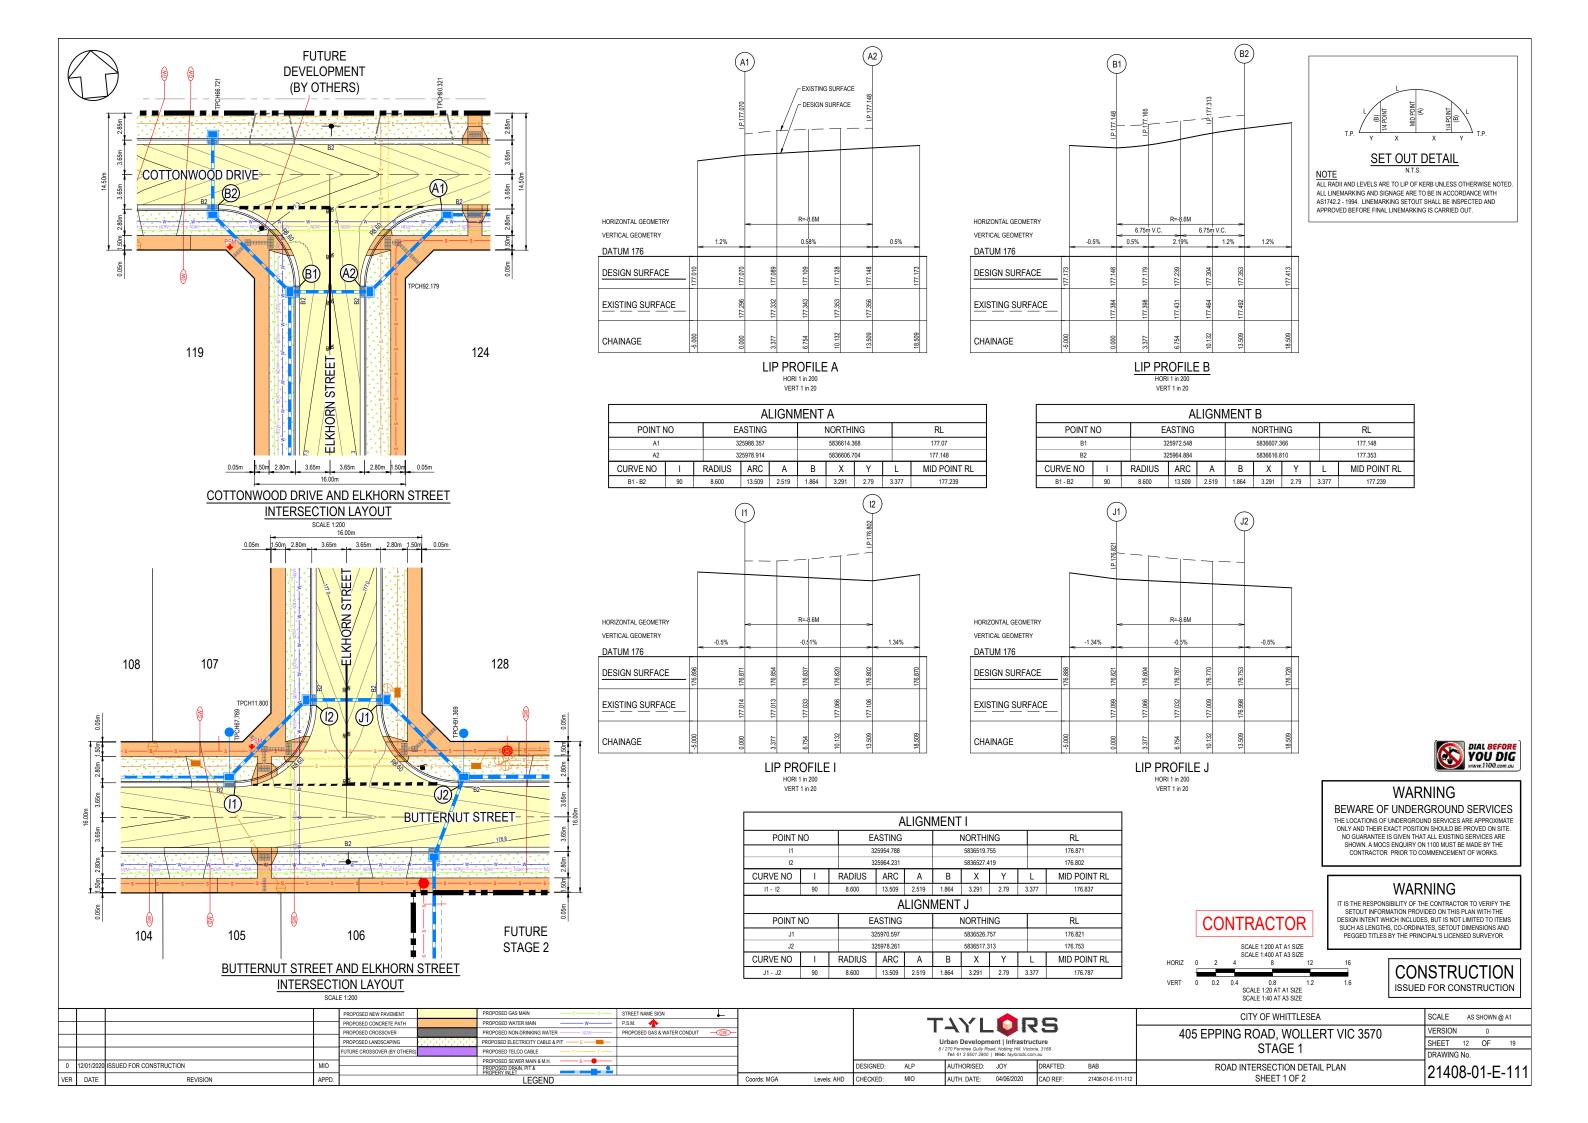


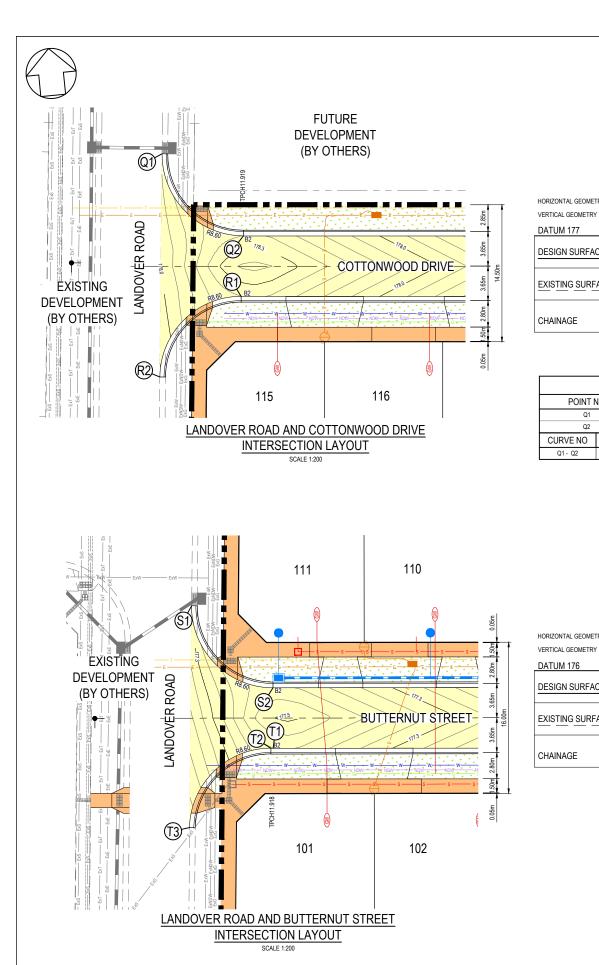

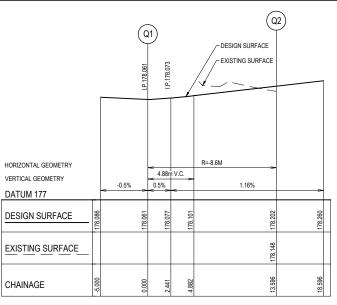




ALIGNMENT Q													
POINT NO EASTING NORTHING RL													
Q1		3	25903.383			5836638.3	376		178.061				
Q2		3	25911.037			5836628.8	346		178.202				
CURVE NO	- 1	RADIUS	RADIUS ARC		A B X Y		L	MID POINT RL					
Q1 - Q2	90.578	8.600	13.596	2.55	1.887	3.311	2.801	3.399	178.124				

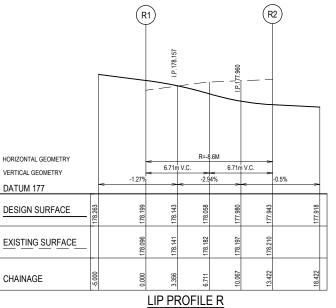




ALIGNMENT R												
POINT	POINT NO EASTING NORTHING											
R1		33	325910.139				505		178.199			
R2		33	325900.704				27		177.943			
CURVE NO	- 1	RADIUS	ARC	Α	В	Х	Υ	L	MID POINT RL			
R1 - R2	89.422 8.600 13.422 2.488 1.842 3.271 2.779						3.356 178.058					

(S2)

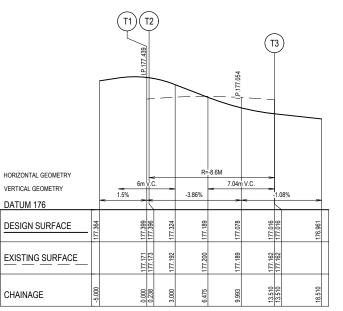

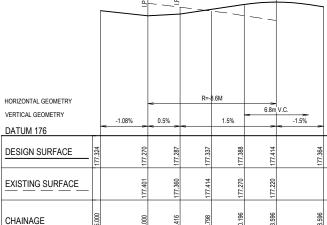

LIP PROFILE S

VERT 1 in 20

DIAL BEFORE YOU DIG

LIP PROFILE T

	ALIGNMENT S												
POINT	VO	E	ASTING			NORTHI	NG		RL				
S1		3.	325891.581				163		177.27				
S2		3:	25899.236			5836525.5	i33		177.414				
CURVE NO	_	RADIUS	ARC	Α	В	Х	Υ	L	MID POINT RL				
S1 - S2	90.578	8.600	13.596	2.55	1.887	3.311	2.801	3.399	177.337				
			Α	LIGNI	MENT	Τ							
POINT I	VO	E	ASTING			NORTHI	NG		RL				
T1		3:	25898.574			5836519.1	68		177.399				
T2		3:	25898.337			5836519.1	92		177.396				
T3		3	25888.921			5836511.7	64		177.016				
CURVE NO	I	RADIUS	ARC	Α	В	Х	Υ	L	MID POINT RL				
T2 - T3	88.423	8.600	13.272	2.436	1.804	3.236	2.761	3.318	177.174				

WARNING


BEWARE OF UNDERGROUND SERVICES

SET OUT DETAIL ALL RADII AND LEVELS ARE TO LIP OF KERB UNLESS OTHERWISE NOTED. ALL LINEMARKING AND SIGNAGE ARE TO BE IN ACCORDANCE WITH AS1742.2 - 1994. LINEMARKING SETOUT SHALL BE INSPECTED AND APPROVED BEFORE FINAL LINEMARKING IS CARRIED OUT.

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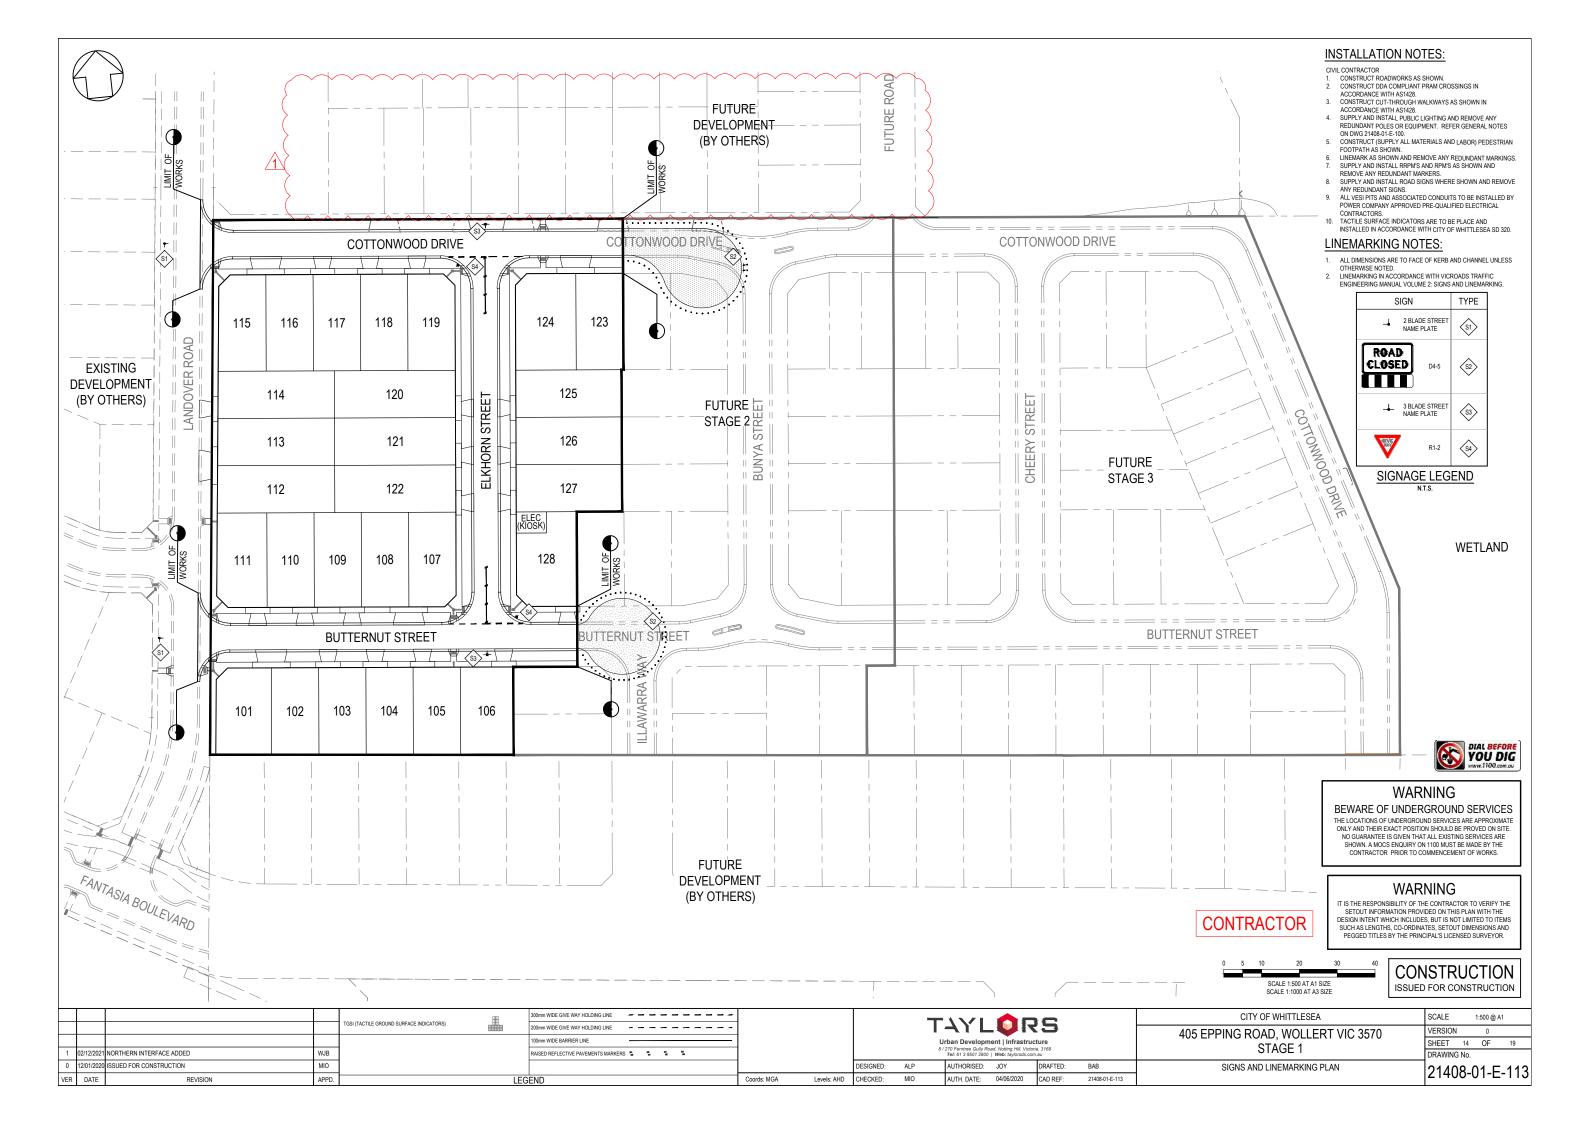



CONTRACTOR

CONSTRUCTION	
ISSUED FOR CONSTRUCTION	l

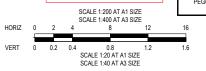			PROPOSED NEW PAVEMENT	PROPOSED GAS MAIN STREET NAME SIGN						_			CITY OF WHITTLESEA	SCALE AS SHOWN @ A1
	+		PROPOSED CONCRETE PATH	PROPOSED WATER MAIN — W— P.S.M.				Т	コンロ		} 🗲	L		
			PROPOSED CROSSOVER	PROPOSED NON-DRINKING WATER — NDW PROPOSED GAS & WATER CONDUIT — GW					~! L	- 🕶 🛚 🔻	. •		405 EPPING ROAD, WOLLERT VIC 3570	VERSION 0
			PROPOSED LANDSCAPING	 PROPOSED ELECTRICITY CABLE & PIT —— E —————					Jrban Developm					SHEET 13 OF 19
				PROPOSED TELCO CABLE T T				8	/ 270 Ferntree Gully Ro Tel: 61 3 9501 2800				STAGE 1	DRAWING No.
	12/01/202	A ISSUED FOR CONSTRUCTION MIC		PROPOSED SEWER MAIN & M.H. S			DESIGNED:	AI P	AUTHORISED:	IOV	DRAFTED:	DAD	DOAD INTEROCOTION DETAIL DUAN	
U	12/01/202	UISSUED FOR CONSTRUCTION INIO	_	PROPOSED DRAIN, PIT &			DESIGNED:	ALP	AUTHURISED:	JUT	DRAFTED:	BAB	ROAD INTERSECTION DETAIL PLAN	21408-01-E-112
VER	DATE	REVISION APPD	l.	LEGEND	Coords: MGA	Levels: AHD	CHECKED:	MIO	AUTH. DATE:	04/06/2020	CAD REF:	21408-01-E-111-112	SHEET 2 OF 2	21400-01-L-112

SCALE	AS	SHOWN (@ A1
VERSION		0	
SHEET	13	OF	1
DRAWING	Nο		



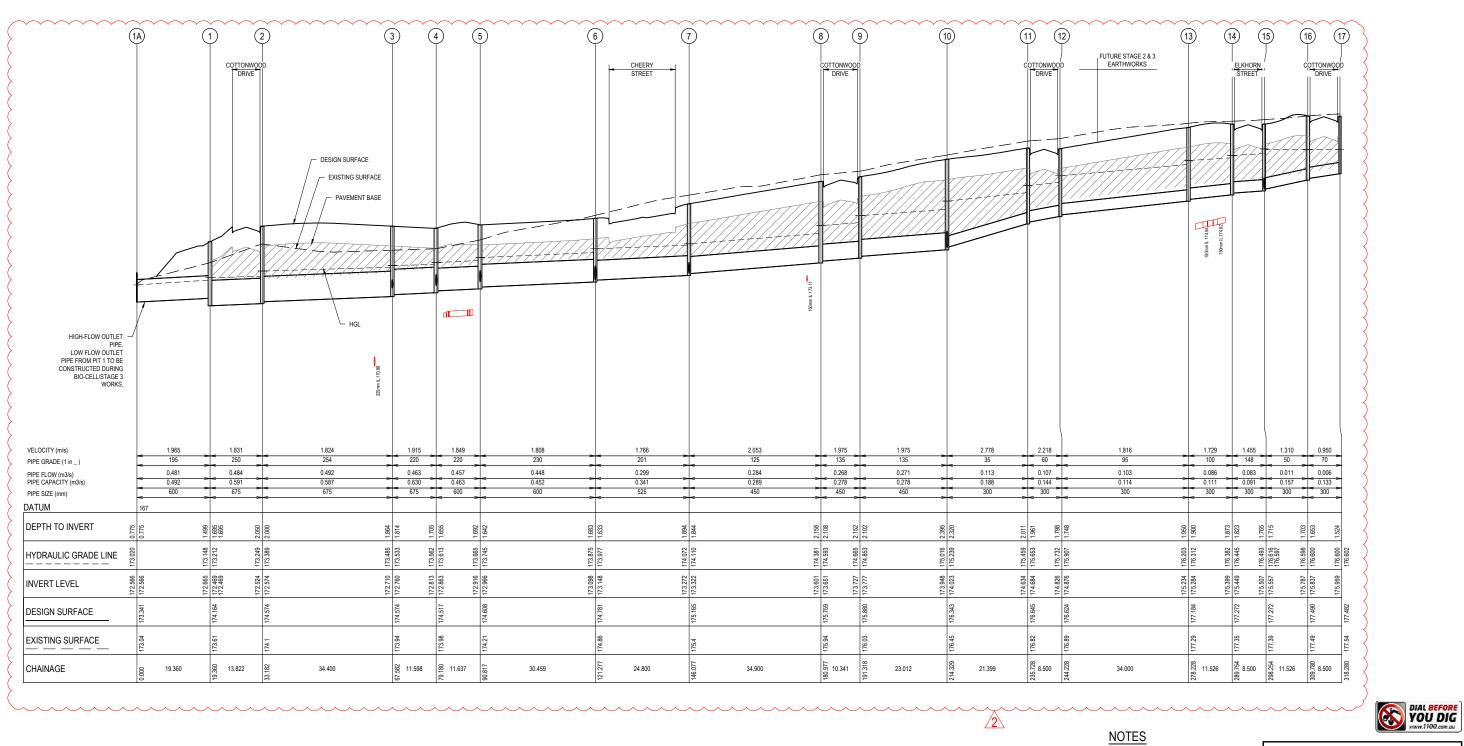

WARNING

PIPES ARE TO BE CLASS 2 AND RRJ UNLESS
NOTED OTHERWISE

NOTED OTHERWISE.

STRUCTURAL FILL USED ONLY WHEN EXISTING SURFACE IS BELOW FOOTPATH.

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WARNING

CONTRACTOR

SCALE 1:500 AT A1 SIZE
5 10 20 30 44

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5 10 20 30 40

0.5 1 2 3 4

SCALE 1:50 AT A1 SIZE SCALE 1:100 AT A3 SIZE

CONSTRUCTION
ISSUED FOR CONSTRUCTION

2	10/11/2021	DRAINAGE LONGITUDINAL SECTION UPDATED	WJB
1	20/07/2021	DRAINAGE LONGITUDINAL SECTION UPDATED	CSH
0	12/01/2020	ISSUED FOR CONSTRUCTION	MIO
VER	DATE	REVISION	APPD.

LEGEND

DENOTES 20mm CLASS 2 FCR BACKFILL

BAB

CITY OF WHITTLESEA


405 EPPING ROAD, WOLLERT VIC 3570
STAGE 1

SCALE	1:5	00 H, 1:50 \	/ @A1
VERSION		2	
SHEET	15	OF	19
DDAMING	NI.		

DRAINAGE LONGITIDUNAL SECTIONS
SHEET 1 OF 3

DRAWING No.

21408-01-E-114

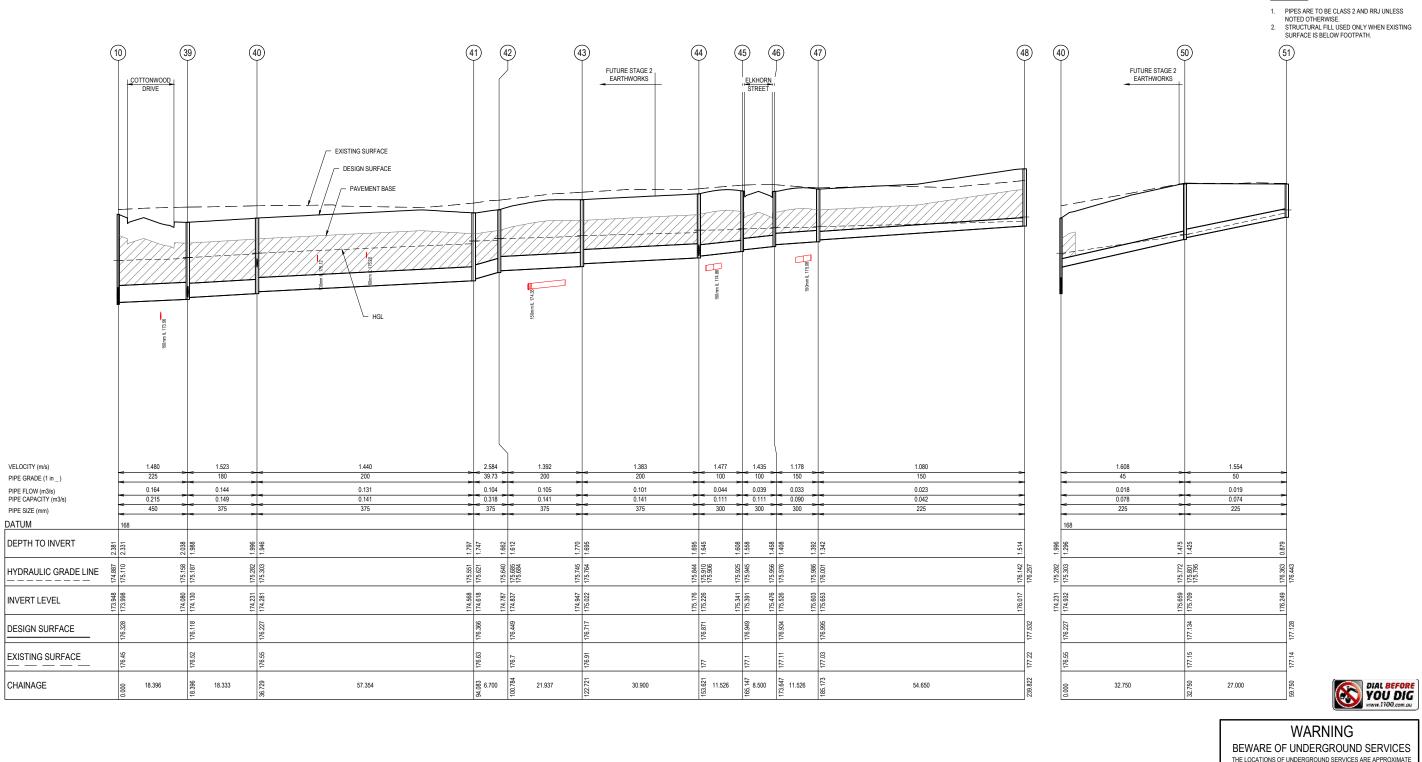

BEWARE OF UNDERGROUND SERVICES


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NOTES




CONTRACTOR

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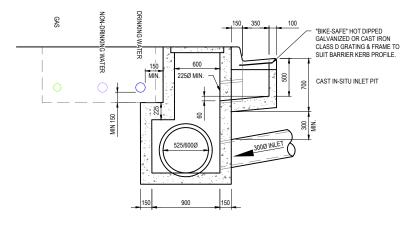
CONSTRUCTION ISSUED FOR CONSTRUCTION

			LEGEND					1///) C		CITY OF WHITTLESEA	SCALE 1:500 H, 1:50 V @A1
			DENOTES 20mm CLASS 2 FCR BACKFILL				Urban Development Infrastructure 8 / 270 Ferntree Guly Poad, Noting HII. Victoria, 3168 Tel: 61 3 8801 2800 Web: Haylonds com.au					405 EPPING ROAD, WOLLERT VIC 3570 STAGE 1	VERSION 0 SHEET 16 OF 19 DRAWING No.
0	12/01/2020	0 ISSUED FOR CONSTRUCTION MI				DESIGNED:	ALP	AUTHORISED:	JOY	DRAFTED:	BAB	DRAINAGE LONGITIDUNAL SECTIONS	21408-01-E-115
VER	DATE	REVISION AP	D.	Coords: MGA	Levels: AHD	CHECKED:	MIO	AUTH. DATE:	04/06/2020	CAD REF:	21408-01-E-114-116	SHEET 2 OF 3	21400-01-L-113

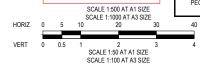


								<u> </u>	I SCH	EDULE		
		PIT		INTE	RNAL	INL	ET.	OUT	LET	PI	Γ	DE1.1.01/0
NAME	TYPE	EASTING	NORTHING	WD	LEN	DIA	INV LEV	DIA	INV LEV	SETOUT RL	DEPTH	REMARKS
1A	EW	326216.331	5836542.932	-	-	600	172.566			173.341	0.775	CONSTRUCT OUTFALL AS PER MW SD 7251-08-103
1	JP	326197.522	5836547.516	0.6	0.9	675	172.469	600	172.665	174.164	1.499	CONSTRUCT AS PER EDCM 605. PROVIDE 375mm BLOCKOUT @ IL172.419 ON SOUTH WAL FUTURE CONNECTION
								FUT.375	172.419			
2	JP(FUT. GSEP)	326184.259	5836543.625	0.9	0.9	675	172.574	675	172.524	174.574	2.05	CONSTRUCT AS PER EDCM 605 AND HAUNCH AS PER TYPICAL DETAIL. PIT TO BE MODIFIE
												GSEP IN STAGE 3. CONSTRUCT AS PER EDCM 605 AND HAUNCH AS PER TYPICAL DETAIL. PROVIDE 225mm BL
3	JP	326174.575	5836576.634	0.9	0.9	675	172.76	675	172.71	174.574	1.864	@ IL172.934 ON WEST WALL FOR FUTURE CONNECTION
	ID/CLIT					FUT.225	172.934					
4	JP(FUT. GSEP)	326171.31	5836587.763	0.9	0.9	600	172.863	675	172.813	174.517	1.705	CONSTRUCT AS PER EDCM 605 AND HAUNCH AS PER TYPICAL DETAIL. PIT TO BE MODIFIE DGSEP IN STAGE 3.
						FUT.300	173					
5	JP(FUT.	326162.368	5836595.211	0.9	0.9	600	172.966	600	172.916	174.608	1.692	CONSTRUCT AS PER EDCM 605 AND HAUNCH AS PER TYPICAL DETAIL. PROVIDE 300mm BL. @ IL173.103 ON NORTH WALL FOR FUTURE CONNECTION. PIT TO BE MODIFIED INTO GS
	GSEP)	020102.000	000000.211	0.0	0.0				172.010		1.002	STAGE 3.
						FUT.300	173.103					CONCEDUCT AS DED EDGM OSS AND HALBIOLIAG DED TYPICAL DETAIL DDG//DE 275 DI
6	JP	326132.072	5836598.362	0.9	0.9	525	173.148	600	173.098	174.781	1.683	CONSTRUCT AS PER EDCM 605 AND HAUNCH AS PER TYPICAL DETAIL. PROVIDE 375mm BLG @ IL173.148 ON SOUTH WALL FOR FUTURE CONNECTION
						FUT.375	173.148					
7	JP(FUT. GSEP)	326107.406	5836600.928	0.9	0.9	450	173.322	525	173.272	175.165	1.894	CONSTRUCT AS PER EDCM 605, HAUNCH AS PER TYPICAL DETAIL AND PROVIDE CLASS D PIT TO BE MODIFIED INTO GSEP IN STAGE 3.
	GOLI)					FUT.300	173.359					FIT TO BE MODIFIED INTO GSEF IN STAGE 3.
8	JP	326072.693	5836604.539	0.9	0.9	450	173.651	450	173.601	175.759	2.158	CONSTRUCT AS PER EDCM 605
9	JP	326067.714	5836613.603	0.6	0.9	450	173.777	450	173.727	175.88	2.152	CONSTRUCT AS PER EDCM 605
10	JP	326044.826	5836615.984	0.6	0.9	300	174.023	450	173.948	176.343	2.395	CONSTRUCT AS PER EDCM 605
						450	173.998					
11	JP(FUT. GSEP)	326023.542	5836618.198	0.6	0.9	300	174.684	300	174.634	176.645	2.011	CONSTRUCT AS PER EDCM 605 AND PROVIDE CLASS D COVER. PIT TO BE MODIFIED INTO 0 STAGE 2.
12	JP(FUT.	326022.663	5836609.744	0.6	0.9	300	174.876	300	174.826	176.624	1.798	CONSTRUCT AS PER EDCM 605 AND PROVIDE CLASS D COVER. PIT TO BE MODIFIED INTO
	GSEP)											STAGE 2.
13	JP	325988.845	5836613.262	0.6	0.9	300	175.284	300	175.234	177.184	1.95	CONSTRUCT AS PER EDCM 605
14	GSEP	325979.896	5836605.999	0.6	0.9	300	175.449	300	175.399	177.272	1.873	CONSTRUCT AS PER EDCM 601
15	GSEP	325971.441	5836606.878	0.9	0.6	300	175.557	300	175.507	177.272	1.765	CONSTRUCT AS PER EDCM 601
16	GSEP	325964.178	5836615.828	0.6	0.9	300 300	175.557 175.837	300	175.787	177.49	1.703	CONSTRUCT AS PER EDCM 601
17	GSEP	325965.058	5836624.282	0.0	0.6	300	173.007	300	175.767	177.482	1.524	CONSTRUCT AS PER EDCM 601
$\overline{}$	JP(FUT.	~~~	\sim	$\overline{}$	\sim	~~	~~	$\overline{}$	\sim			CONSTRUCT AS PER EDCM 605. PROVIDE 300mm BLOCKOUT @ 1L174.130 ON EAST WALL
39	GSEP)	326042.874	5836597.692	0.6	0.9	375	174.13	450	174.08	176.118	2.038	FUTURE CONNECTION. PIT TO BE MODIFIED INTO GSEP IN STAGE 2.
40	ID.	200040 077	F020F70 4F7	0.0	0.0	FUT.300	174.13	275	474 004	470 007	1.000	CONCEDIAT AS DED EDON OF
40	JP	326040.977	5836579.457	0.6	0.9	375 225	174.281 174.932	375	174.231	176.227	1.996	CONSTRUCT AS PER EDCM 605
	JP(FUT.									.=		
41	GSEP)	326035.043	5836522.411	0.6	0.9	375	174.618	375	174.568	176.366	1.797	CONSTRUCT AS PER EDCM 605. PIT TO BE MODIFIED INTO GSEP IN STAGE 2.
42	JP	326031.581	5836516.674	0.6	0.9	375	174.837	375	174.787	176.449	1.662	CONSTRUCT AS PER EDCM 605 AND PROVIDE CLASS D COVER
43	JP(FUT. GSEP)	326009.701	5836515.098	0.6	0.9	375	175.022	375	174.947	176.717	1.77	CONSTRUCT AS PER EDCM 605. PIT TO BE MODIFIED INTO GSEP IN STAGE 2.
44	JP	325978.966	5836518.295	0.6	0.9	300	175.226	375	175.176	176.871	1.695	CONSTRUCT AS PER EDCM 605
						300	175.226					
45	GSEP	325971.703	5836527.245	0.9	0.6	300	175.391	300	175.341	176.949	1.608	CONSTRUCT AS PER EDCM 601
46	GSEP	325963.249	5836528.124	0.9	0.6	300	175.526	300	175.476	176.934	1.458	CONSTRUCT AS PER EDCM 601
47	GSEP	325954.299	5836520.861	0.6	0.9	225	175.653	300	175.603	176.995	1.392	CONSTRUCT AS PER EDCM 601
48	JP	325899.943	5836526.516	0.6	0.9			225	176.017	177.532	1.514	CONSTRUCT AS PER EDCM 605
50	JP	326008.403	5836582.846	0.6	0.9	225	175.709	225	175.659	177.134	1.475	CONSTRUCT AS PER EDCM 605
51	JP	326005.610	5836555.991	0.6	0.9	200	475 004	225	176.249	177.128	0.879	CONSTRUCT AS PER EDCM 605
52	GSEP	325974.953	5836510.167	0.9	0.6	300	175.321	300	175.271	176.887	1.616	CONSTRUCT AS PER EDCM 601
53	JP ID	325972.268	5836484.285	0.6	0.9	300	175.525	300	175.475	176.927	1.361	CONSTRUCT AS PER EDCM 605
54 55	JP JP	325903.475 325969.338	5836491.775 5836586.658	0.6	0.9	225	175.709	300	175.91 175.659	176.772 177.374	0.772 1.715	CONSTRUCT AS PER EDCM 605 CONSTRUCT AS PER EDCM 605
	JF.	020003.000	5000000.000	0.0	0.5	225	175.709	300	110.000	111.514	1.710	CONSTRUCT AS FER EDUM 003
56	JP	325933.022	5836590.436	0.9	0.6	225	176.419	225	176.369	177.805	1.435	CONSTRUCT AS PER EDCM 605
						150	176.419					
57	JP	325930.461	5836565.819	0.6	0.9			225	176.667	177.604	0.937	CONSTRUCT AS PER EDCM 605
58	JP	325966.151	5836556.024	0.6	0.9			225	175.863	177.278	1.415	CONSTRUCT AS PER EDCM 605
	JP	325913.39	5836592.478	0.6	0.9			150	176.912	177.994	1.082	CONSTRUCT AS PER EDCM 605
59	JI											

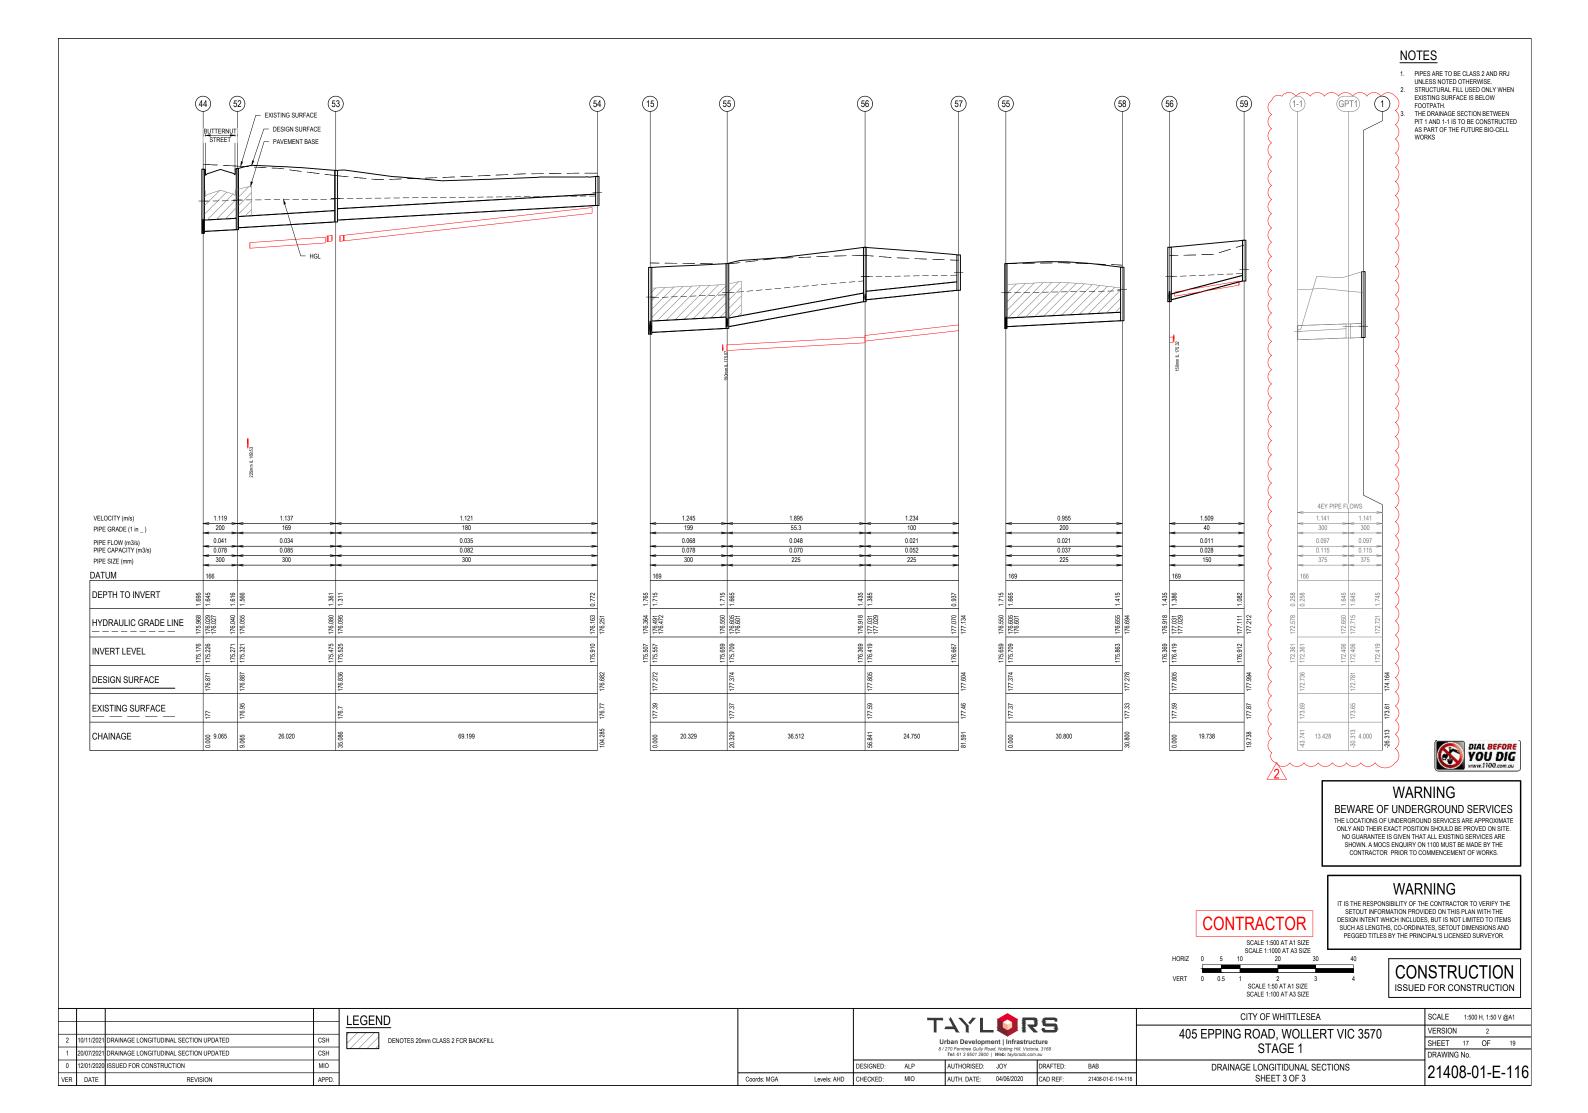- 2. SETOUT LEVEL TO PIT COVER LEVEL
- 3. SOME SETOUT XY OR Z LEVELS HAVE SPECIAL SETOUT DATA. SEE INDIVIDUAL MANHOLE REMARKS
- 4. ALL PITS LOCATED IN FUTURE STAGES ARE TO BE CONSTRUCTED AS A JP (EDCM 605) AND TO FINISHED SURFACE LEVELS
- 5. FILL IS TO BE PROVIDED AROUND THE PITS WHERE TOP OF PITS ARE ABOVE ES LEVELS
- 6. NO PONDING IS TO OCCUR WHERE PITS ARE BELOW ES LEVEL



TYPICAL DETAIL HAUNCHED PIT

LIP OF KERB

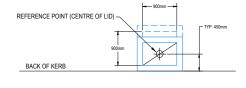

PIT SETOUT POINT

LEGEND:

JP JUNCTION PIT
GSEP GRATED SIDE ENTRY PIT
DGSEP DOUBLE GRATE SIDE ENTRY PIT



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CONSTRUCTION ISSUED FOR CONSTRUCTION

2	10/11/2021	DRAINAGE PIT SCHEDULE UPDATED	WJB
1	20/07/2021	DRAINAGE PIT SCHEDULE UPDATED	CSH
0	12/01/2020	ISSUED FOR CONSTRUCTION	MIO
VER	DATE	REVISION	APPD.

		TAYLORS Urban Development Infrastructure 8/270 Ferritres Guily Road, Noting, Hil. Victoria, 3168 Tel: 61 39 967 2800 Web: Indyordas com au								
		DESIGNED:	ALP		AUTHORISED:	JOY	DRAFTED:	BAB		
Coords: MGA	Levels: AHD	CHECKED:	MIO		AUTH. DATE:	04/06/2020	CAD REF:	21408-0		

CITY OF WHITTLESEA 405 EPPING ROAD, WOLLERT VIC 3570 STAGE 1

SCALE AS SHOWN VERSION SHEET 18 OF DRAWING No.

DRAINAGE PIT SCHEDULE AND TYPICAL PIT DETAIL

21408-01-E-117

